

GENERAL NOTES

1. All services to be disconnected

2. All redundant services to be removed

3. For boundaries and site details refer to Surveyor's drawings

4. For all demolition works and procedures refer to AS2601
5. Refer to AS4964 for identifying asbestos
6. Refer to Safe Work Australia 2016 before commencing works
7. Contact DIAL BEFORE YOU DIG to identify location of underground

utilities and service pipes and cables

8. Excavation: Do not excavate by machine within 1m of existing underground services

9. If temporary support is required, certification for its design and installation is required from a professional engineer engaged by the

contractor

10. Existing buildings: Until permanent support is provided, provide temporary support for sections of existing buildings which are to be

altered and which normally rely for support on work to be demolished **11.** Ground support: Support excavations for demolition of underground

12. Adjacent structures: Provide supports to adjacent structures where necessary, sufficient to prevent damage resulting from the works

13. Refer to Civil Engineer's drawings for extent of roadworks and public

14. Notice of Works

Inspection: Give notice so that inspection may be made of the following:
- Adjacent structures before starting and at completion of demolition

Services before disconnection or diversion
Trees documented to be retained, before starting demolition
Contents of building before starting demolition
Structure after stripping and removal of roof coverings and external

Underground structures after demolition above them
 Excavations remaining after removal of underground work
 Site after removal of demolished materials

- Services after reconnection or diversion

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Paynter Dixon Level 2 2 Richardson Place Riverside Corporate Park North Ryde NSW 2113

---- EXISTING SITE BOUNDARY EXISTING STRUCTURE TO BE DEMOLISHED 15-31 Harbour Drive Harbour Drive Coffs Harbour State Postcode Country

Siteworks


Demolition Plan

BF For DA Submission 01 11.12.20

TURNER

DLCS Quality Endorsed Company ISO 9001:2015, Registration Number 20476 Nominated Architect: Nicholas Turner 6695, ABN 86 064 084 911



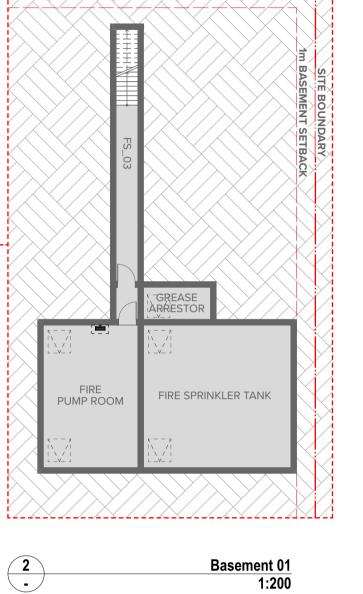

External walls		
	CFC sheet + R2.0 Insulation + PB	As per plan, Medium colour
	Colour back glass + R2.0 Insulation + PB	As per plan, Medium colour
	Hebel+ R2.0 Insulation + PB	As per plan, Medium colour
Internal walls	Plasterboard on stud	Within apartments
	Hebel + Acoustic Insulation +PB	Bwtween apartment or to commor area
Windows	Aluminium frame,	NFRC Glazing System
	Single glazed, Clear	(Glass+Frame) values: ⇒ U = 6.7 and SHGC = 0.70
	Throughout, UNO	(All sliding/fixed/louvre
		windows/doors)
		⇒ U = 6.7 and SHGC = 0.57
		(All awning/casement windows/doors)
		Weather stripping fitted on window
	Aluminium frame, Single glazed, low solar gain Low-E	NFRC Glazing System (Glass+Frame) values:
	To units	⇒ U = 5.6 and SHGC = 0.41
	101,201,202,203,301,302,303,401,402,403,708,1007 all windows/doors	(All sliding/fixed/louvre windows/doors)
		⇒ U = 5.6 and SHGC = 0.36
		(All awning/casement windows/doors)
		Weather stripping fitted on window
	Aluminium frame, Single glazed, High solar gain Low-E	NFRC Glazing System (Glass+Frame) values:
	To units	⇒ U = 5.4 and SHGC = 0.58
	505,604,703,704,705,803,804,903,904,1003,1004,1103 1201(kitchen/living only) all windows/doors	(All sliding/fixed/louvre windows/doors)
		⇒ U = 5.4 and SHGC = 0.49
		(All awning/casement windows/doors)
		Weather stripping fitted on window
	Aluminium frame, Double glazed, Clear	NFRC Glazing System (Glass+Frame) values:
	To unit 406 (kitchen/living only),409 ,508(kitchen/living	⇒ U = 4.8 and SHGC = 0.59
	only),607(kitchen/living only) 706(kitchen/living only),1204 all windows/doors	(All sliding/fixed/louvre windows/doors)
		⇒ U = 4.8 and SHGC = 0.51 (All awning/casement windows/doors)
		Weather stripping fitted on window
	Aluminium frame,	NFRC Glazing System
	Double glazed, High solar gain Low-E	(Glass+Frame) values: ⇒ U = 4.3 and SHGC = 0.47
	To unit 410,509,608,707,805,806,905,906,1005,1006,1104,1203 all windows/doors	⇒ U = 4.3 and SHGC = 0.47 (All sliding/fixed/louvre windows/doors)
		⇒ U = 4.3 and SHGC = 0.53
		(All awning/casement windows/doors)
		Weather stripping fitted on window
Skylights	N/A	
Floor	Concrete floor	Tile (Bathroom, laundry and kitchen) Timber (Living and bedroom)
	Concrete floor with R2.0 floor insulation	To floor above unconditioned space
Roof	Concrete + R3.5 Insulation + PB	Medium colour
:		

:200	@A1, 50	%@A3	20023	BI	
cale			Project No.	Drawn by	
ev	Date	Approved by	Revision Notes		
)2	11.11.20	BF	For Coordination		
)3	20.11.20	BF	For Coordination		
)4	27.11.20	BF	For Coordination		
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9	06.05.21	BF	Amendment as per CHCC comm	nents	
10	26.05.21	BF	Amendment as per CHCC comn	nents	

15-31 Harbour Drive Harbour Drive Coffs Harbour State Postcode Country Drawing Title **GA Plans**

Ground Level

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Paynter Dixon Level 2 2 Richardson Place Riverside Corporate Park North Ryde NSW 2113

DA Submission

Exhaust fans All exhaust fans to have draft stoppers attached.

_____ ROLLER SHUTTER_____ VOID TO LOADING BAY BELOW s | s | s | s | s | s | s | s | RL 7.20 RL 7.20 AA9
DA-310-001 AWNING EXTEND SHOWN DOTTED NT LOT AWNING OUTLINE BELOW ADJĀCĒNT LOT AWNING OUT \$1 DA-210-001 Mezzanine Level

ENT LOT AWNING OUTLINE BELOW AWNING EXTEND SHOWN DOTTED

15-31 Harbour Drive Harbour Drive Coffs Harbour State Postcode Country Drawing Title **GA Plans Mezzanine Level**

ADJACENT LOT AWNING OUT

Amendment as per CHCC comments Amendment as per CHCC comments 06 26.05.21 05 09.03.21 04 11.12.20 For DA Submission
 03
 08.12.20
 BF
 For Coordination

 02
 01.12.20
 BF
 For Coordination

 01
 27.11.20
 BF
 For Coordination
 Rev Date Approved by Revision Notes Project No. 1:200 @A1, 50%@A3 Dwg No. **DA-110-005** Status **DA Submission**

Basix Building Fabric Requirements

Single glazed, Clear Throughout, UNO

Internal walls Plasterboard on stud

Windows Aluminium frame,

Colour back glass + R2.0 Insulation + PB

Hebel+ R2.0 Insulation + PB

Aluminium frame, Single glazed, low solar gain Low-E

Aluminium frame, Single glazed, High solar gain Low-E

Aluminium frame, Double glazed, High solar gain Low-E

Concrete floor with R2.0 floor insulation

Concrete + R3.5 Insulation + PB

Exhaust fans All exhaust fans to have draft stoppers attached.

Downlights All LED downlights

To units 101,201,202,203,301,302,303,401,402,403,708,1007 all windows/doors

Aluminium frame, Double glazed, Clear To unit 406 (kitchen/living only),409 ,508(kitchen/living only),607(kitchen/living only) 706(kitchen/living only),1204 all windows/doors

To units
505,604,703,704,705,803,804,903,904,1003,1004,1103
4201/*k*-itchen/livina only) all windows/doors

⇒ U = 5.4 and 5.100 €
(All sliding/fixed/louvre windows/doors)

Double grazed, ringin solar gall. □

To unit

410,509,608,707,805,806,905,906,1005,1006,1104,1203

all windows/doors

□ U = 4.3 and SHGC = 0.47

(All sliding/fixed/louvre windows/doors)

□ U = 4.3 and SHGC = 0.53

As per plan, Medium colour

Bwtween apartment or to common

As per plan, Medium colour

As per plan, Medium colour

NFRC Glazing System (Glass+Frame) values: ⇒ U = 6.7 and SHGC = 0.70

(All sliding/fixed/louvre windows/doors) ⇒ U = 6.7 and SHGC = 0.57

Weather stripping fitted on windows

NFRC Glazing System (Glass+Frame) values:

⇒ U = 5.6 and SHGC = 0.41

⇒ U = 5.6 and SHGC = 0.36 (All awning/casement windows/doors)

NFRC Glazing System (Glass+Frame) values: ⇒ U = 5.4 and SHGC = 0.58

 \Rightarrow U = 5.4 and SHGC = 0.49 (All awning/casement windows/doors)

NFRC Glazing System (Glass+Frame) values: ⇒ U = 4.8 and SHGC = 0.59

 \Rightarrow U = 4.8 and SHGC = 0.51

NFRC Glazing System (Glass+Frame) values: ⇒ U = 4.3 and SHGC = 0.47

Weather stripping fitted on windows

Weather stripping fitted on windows

To floor above unconditioned space

Tile (Bathroom, laundry and kitchen)
Timber (Living and bedroom)

(All awning/casement windows/doors)

(All awning/casement windows/doors)

Medium colour

Weather stripping fitted on windows

Weather stripping fitted on windows

(All awning/casement windows/doors)

Within apartments

TURNER

DLCS Quality Endorsed Company ISO 9001:2015, Registration Number 20476 Nominated Architect: Nicholas Turner 6695, ABN 86 064 084 911

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HARBOUR DRIVE



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	Hebel + Acoustic Insulation +PB	Bwtween apartment or to common area
Windows	Aluminium frame,	NFRC Glazing System
	Single glazed, Clear	(Glass+Frame) values:
	Throughout, UNO	⇒ U = 6.7 and SHGC = 0.70 (All sliding/fixed/louvre
		windows/doors) ⇒ U = 6.7 and SHGC = 0.57
		(All awning/casement
		windows/doors)
		Weather stripping fitted on window
	Aluminium frame, Single glazed, low solar gain Low-E	NFRC Glazing System (Glass+Frame) values:
	To units	⇒ U = 5.6 and SHGC = 0.41
	101,201,202,203,301,302,303,401,402,403,708,1007	(All sliding/fixed/louvre
	all windows/doors	windows/doors)
		\Rightarrow U = 5.6 and SHGC = 0.36
		(All awning/casement windows/doors)
		Weather stripping fitted on window
	Aluminium frame,	NFRC Glazing System (Glass+Frame) values:
	Single glazed, High solar gain Low-E	(Glass+Frame) values: ⇒ U = 5.4 and SHGC = 0.58
	To units 505,604,703,704,705,803,804,903,904,1003,1004,1103	⇒ 0 = 5.4 and SHGC = 0.58 (All sliding/fixed/louvre
	1201(kitchen/living only) all windows/doors	windows/doors)
	125 (Alleria Anthropy and Anthr	⇒ U = 5.4 and SHGC = 0.49
		(All awning/casement windows/doors)
		Weather stripping fitted on window
	Aluminium frame, Double glazed, Clear	NFRC Glazing System (Glass+Frame) values:
	To unit 406 (kitchen/living only),409 ,508(kitchen/living only),607(kitchen/living only) 706(kitchen/living only),1204 all windows/doors	⇒ U = 4.8 and SHGC = 0.59 (All sliding/fixed/louvre windows/doors)
		⇒ U = 4.8 and SHGC = 0.51
		(All awning/casement windows/doors)
		Weather stripping fitted on window
	Aluminium frame,	NFRC Glazing System
	Double glazed, High solar gain Low-E	(Glass+Frame) values:
	To unit	\Rightarrow U = 4.3 and SHGC = 0.47
	410,509,608,707,805,806,905,906,1005,1006,1104,1203 all windows/doors	(All sliding/fixed/louvre windows/doors)
		⇒ U = 4.3 and SHGC = 0.53
		(All awning/casement windows/doors)
		windows/doors)
Skylights	N/A	windows/doors) Weather stripping fitted on window
Skylights Floor	N/A Concrete floor	windows/doors) Weather stripping fitted on window Tile (Bathroom, laundry and kitchen)
	Concrete floor	windows/doors) Weather stripping fitted on window Tile (Bathroom, laundry and kitchen) Timber (Living and bedroom)
Floor	Concrete floor Concrete floor with R2.0 floor insulation	windows/doors) Weather stripping fitted on window Tile (Bathroom, laundry and kitchen) Timber (Living and bedroom) To floor above unconditioned space
	Concrete floor	windows/doors) Weather stripping fitted on window Tile (Bathroom, laundry and kitchen) Timber (Living and bedroom)
Floor	Concrete floor Concrete floor with R2.0 floor insulation	windows/doors) Weather stripping fitted on window. Tile (Bathroom, laundry and kitchen) Timber (Living and bedroom) To floor above unconditioned space

As per plan, Medium colour

As per plan, Medium colour

As per plan, Medium colour

Basix Building Fabric Requirements

Internal walls Plasterboard on stud

Colour back glass + R2.0 Insulation + PB

Hebel+ R2.0 Insulation + PB

09 26.05.21

08 09.03.21

Amendment as per CHCC comments

Amendment as per CHCC comments



HARBOUR DRIVE



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DLCS Quality Endorsed Company ISO 9001:2015, Registration Number 20476 Nominated Architect: Nicholas Turner 6695, ABN 86 064 084 911 Paynter Dixon
Level 2 2 Richardson Place Riverside
Corporate Park North Ryde NSW 2113

Project Title

15-31 Harbour Drive
Harbour Drive Coffs Harbour State Postcode Country

Drawing Title

GA Plans
Level 02

Internal walls	Plasterboard on stud	Within apartments
	Hebel + Acoustic Insulation +PB	Bwtween apartment or to comparea
Windows	Aluminium frame,	NFRC Glazing System
	Single glazed, Clear	(Glass+Frame) values: ⇒ U = 6.7 and SHGC = 0.70
	Throughout, UNO	(All sliding/fixed/louvre
		windows/doors)
		\Rightarrow U = 6.7 and SHGC = 0.57
		(All awning/casement windows/doors)
		Weather stripping fitted on win
	Aluminium frame, Single glazed, low solar gain Low-E	NFRC Glazing System (Glass+Frame) values:
	To units	\Rightarrow U = 5.6 and SHGC = 0.41
	101,201,202,203,301,302,303,401,402,403,708,1007 all windows/doors	(All sliding/fixed/louvre windows/doors)
		\Rightarrow U = 5.6 and SHGC = 0.36
		(All awning/casement windows/doors)
		Weather stripping fitted on wind
	Aluminium frame, Single glazed, High solar gain Low-E	NFRC Glazing System (Glass+Frame) values:
	To units	\Rightarrow U = 5.4 and SHGC = 0.58
	505,604,703,704,705,803,804,903,904,1003,1004,1103 1201(kitchen/living only) all windows/doors	(All sliding/fixed/louvre windows/doors)
		\Rightarrow U = 5.4 and SHGC = 0.49
		(All awning/casement windows/doors)
		Weather stripping fitted on win
	Aluminium frame, Double glazed, Clear	NFRC Glazing System (Glass+Frame) values:
	To unit 406 (kitchen/living only),409 ,508(kitchen/living only),607 (kitchen/living only) 706(kitchen/living	⇒ U = 4.8 and SHGC = 0.59 (All sliding/fixed/louvre
	only),1204 all windows/doors	windows/doors) ⇒ U = 4.8 and SHGC = 0.51
		(All awning/casement windows/doors)
		Weather stripping fitted on win
	Aluminium frame, Double glazed, High solar gain Low-E	NFRC Glazing System (Glass+Frame) values:
	To unit	⇒ U = 4.3 and SHGC = 0.47
	410,509,608,707,805,806,905,906,1005,1006,1104,1203 all windows/doors	(All sliding/fixed/louvre windows/doors)
		\Rightarrow U = 4.3 and SHGC = 0.53
		(All awning/casement windows/doors)
		Weather stripping fitted on wind
Skylights	N/A	Tile (Detherons learning)
Floor	Concrete floor	Tile (Bathroom, laundry and kitchen)
		Timber (Living and bedroom)
	Concrete floor with R2.0 floor insulation	To floor above unconditioned s
Roof	Concrete + R3.5 Insulation + PB	Medium colour
Downlights	All LED downlights	All downlights comply with AS6 IC-F Rating.

As per plan, Medium colour

As per plan, Medium colour


As per plan, Medium colour

Basix Building Fabric Requirements

Colour back glass + R2.0 Insulation + PB

Hebel+ R2.0 Insulation + PB

A Sı	ubmission		DA-110-020	09	
atus			Dwg No.	Rev	
200	@A1, 50%(@A3	20023	BF	
ale			Project No.	Drawn by	
ev	Date	Approved by	Revision Notes		
1	29.10.20	BF	For Coordination		
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HARBOUR DRIVE

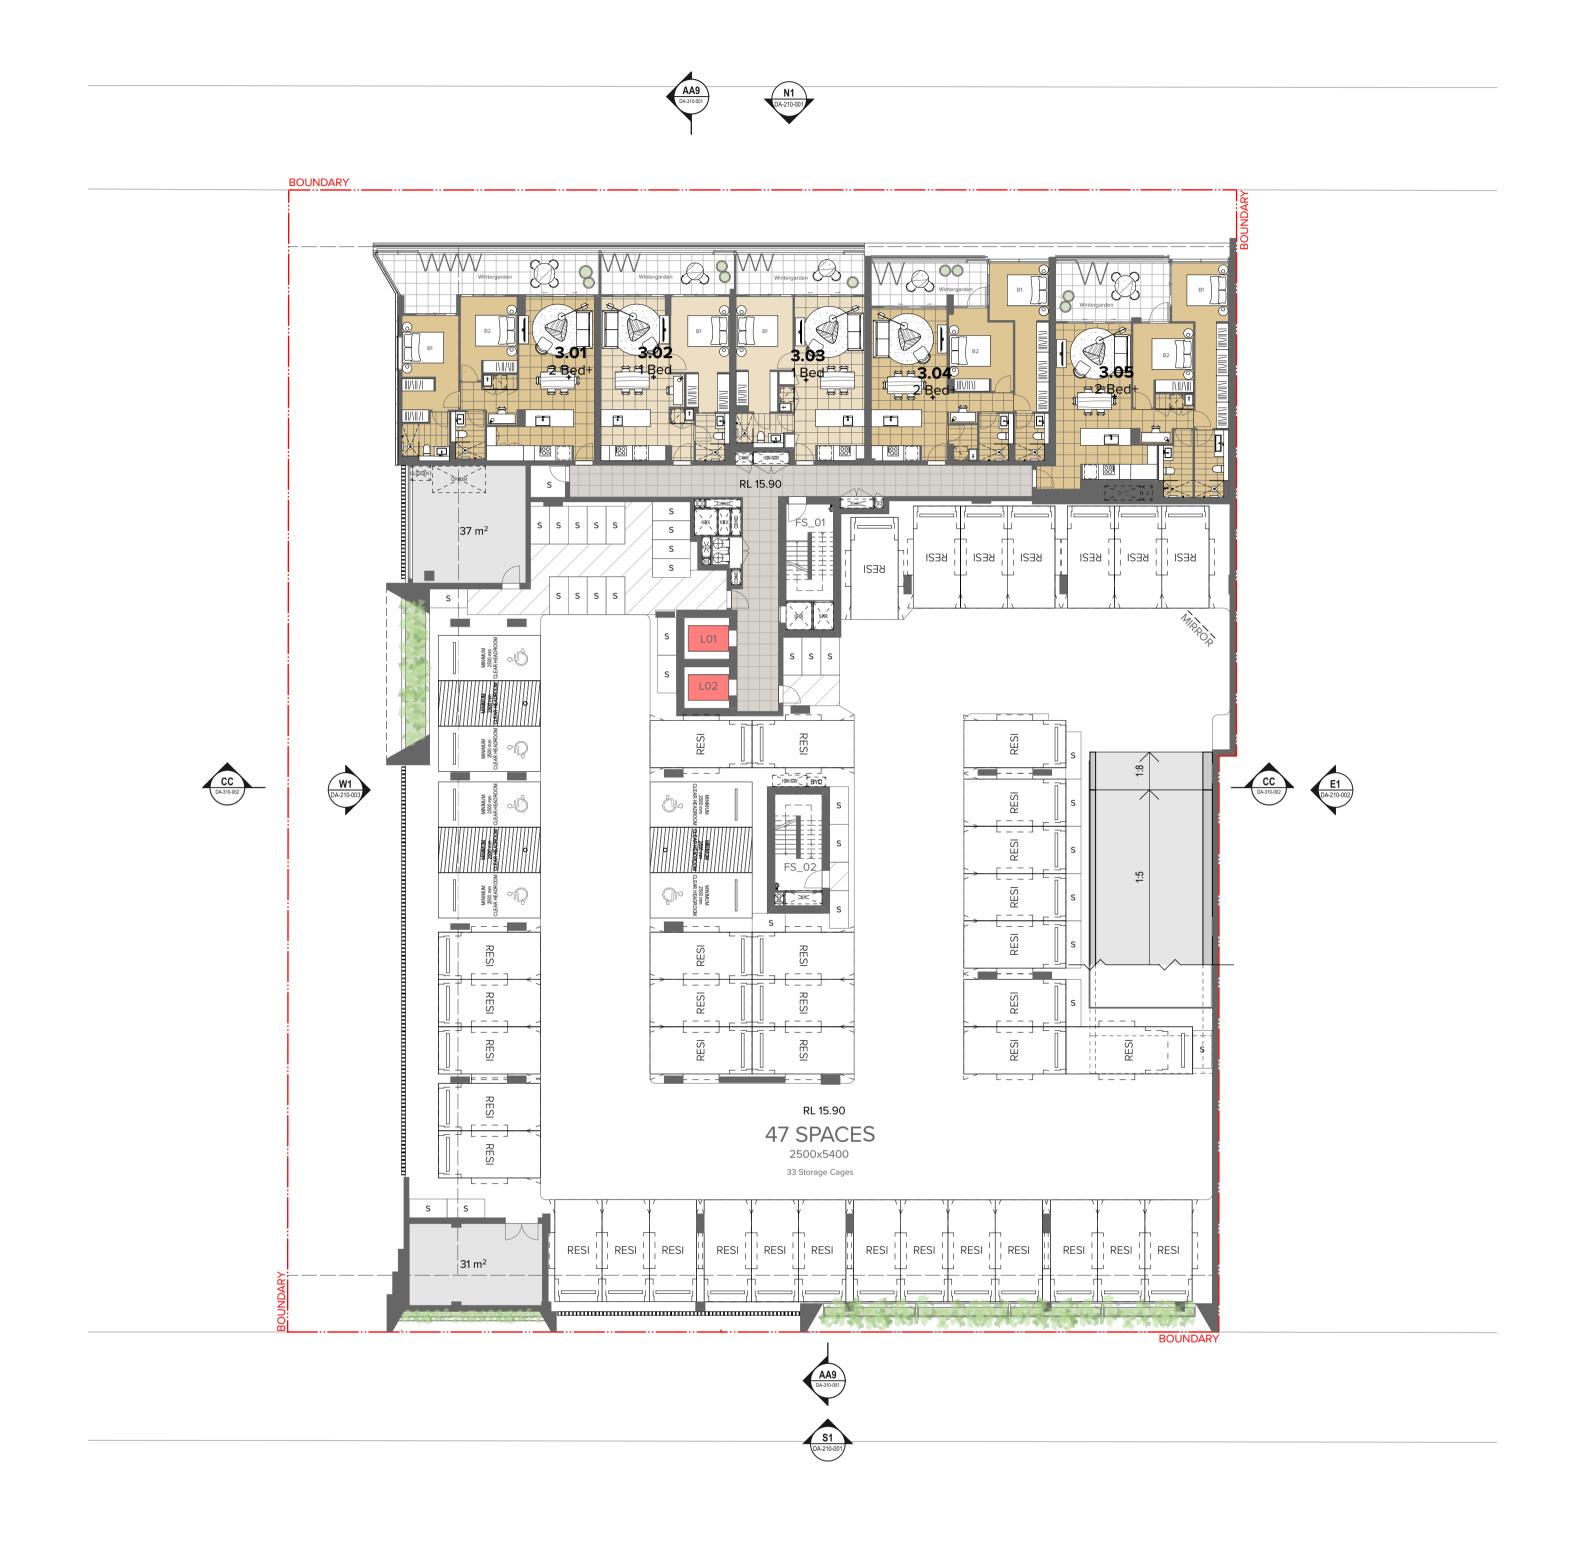

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Paynter Dixon
Level 2 2 Richardson Place Riverside
Corporate Park North Ryde NSW 2113

Project Title

15-31 Harbour Drive
Harbour Drive Coffs Harbour State Postcode Country

Drawing Title

GA Plans
Level 03

		area
Windows	Aluminium frame, Single glazed, Clear	NFRC Glazing System (Glass+Frame) values:
	Throughout, UNO	⇒ U = 6.7 and SHGC = 0.70
		(All sliding/fixed/louvre windows/doors)
		⇒ U = 6.7 and SHGC = 0.57
		(All awning/casement windows/doors)
		Weather stripping fitted on wind
	Aluminium frame,	NFRC Glazing System
	Single glazed, low solar gain Low-E	(Glass+Frame) values: ⇒ U = 5.6 and SHGC = 0.41
	To units 101,201,202,203,301,302,303,401,402,403,708,1007	(All sliding/fixed/louvre
	all windows/doors	windows/doors) ⇒ U = 5.6 and SHGC = 0.36
		(All awning/casement windows/doors)
		Weather stripping fitted on wind
	Aluminium frame, Single glazed, High solar gain Low-E	NFRC Glazing System (Glass+Frame) values:
	To units 505,604,703,704,705,803,804,903,904,1003,1004,1103 1201(kitchen/living only) all windows/doors	⇒ U = 5.4 and SHGC = 0.58 (All sliding/fixed/louvre windows/doors)
		⇒ U = 5.4 and SHGC = 0.49 (All awning/casement windows/doors)
		Weather stripping fitted on wind
	Aluminium frame, Double glazed, Clear	NFRC Glazing System (Glass+Frame) values:
	To unit 406 (kitchen/living only),409 ,508(kitchen/living only),607(kitchen/living only) 706(kitchen/living	⇒ U = 4.8 and SHGC = 0.59 (All sliding/fixed/louvre
	only),1204 all windows/doors	windows/doors)
		⇒ U = 4.8 and SHGC = 0.51 (All awning/casement
		windows/doors)
		Weather stripping fitted on winder
	Aluminium frame, Double glazed, High solar gain Low-E	NFRC Glazing System (Glass+Frame) values:
	To unit	⇒ U = 4.3 and SHGC = 0.47
	410,509,608,707,805,806,905,906,1005,1006,1104,1203 all windows/doors	(All sliding/fixed/louvre windows/doors)
		⇒ U = 4.3 and SHGC = 0.53
		(All awning/casement windows/doors)
		Weather stripping fitted on windo
Skylights	N/A	Tile (Bothroom lawada as d
Floor	Concrete floor	Tile (Bathroom, laundry and kitchen)
	0	Timber (Living and bedroom)
Roof	Concrete floor with R2.0 floor insulation Concrete + R3.5 Insulation + PB	To floor above unconditioned sp Medium colour
NUUI	CONGRET + K3.3 IIISUIBIIOII + FD	Wedicill Colour
Downlights	All LED downlights	All downlights comply with AS60 IC-F Rating.
Exhaust fans	All exhaust fans to have draft stoppers attached.	

As per plan, Medium colour

As per plan, Medium colour

As per plan, Medium colour
Within apartments

Bwtween apartment or to common

Basix Building Fabric Requirements

Colour back glass + R2.0 Insulation + PB

Hebel+ R2.0 Insulation + PB

A Sı	ubmission	<u> </u>	DA-110-030	09	
atus			Dwg No.	Rev	
200	@A1, 50%	6@A3	20023	BF	
ale			Project No.	Drawn by	- 1
ev	Date	Approved by	Revision Notes		
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HARBOUR DRIVE



15-31 Harbour Drive Harbour Drive Coffs Harbour State Postcode Cou **GA Plans** Level 04

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ountry	Status		1	Dwg No.
	1:20	0, 1:1.64 @	A1, 50%@A3	
	Scale			Project No.
	Rev	Date	Approved by	Revision Notes
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	05	08.12.20	BF	For Coordination
	06	11.12.20	BF	For DA Submission

Basix Building Fabric Requirements

Aluminium frame, Single glazed, Clear Throughout, UNO

Colour back glass + R2.0 Insulation + PB

Hebel+ R2.0 Insulation + PB

Aluminium frame, Single glazed, low solar gain Low-E

Aluminium frame, Single glazed, High solar gain Low-E

Aluminium frame, Double glazed, High solar gain Low-E

Concrete floor with R2.0 floor insulation

Concrete + R3.5 Insulation + PB

Exhaust fans All exhaust fans to have draft stoppers attached.

To units 101,201,202,203,301,302,303,401,402,403,708,1007 all windows/doors

Aluminium frame,
Double glazed, Clear
To unit 406 (kitchen/living only),409 ,508(kitchen/living only),607(kitchen/living only),706(kitchen/living only),1204 all windows/doors

To units 505,604,703,704,705,803,804,903,904,1003,1004,1103 (All sliding/fixed/louvre windows/doors)

To unit \Rightarrow U = 4.3 and SHGC = 0 410,509,608,707,805,806,905,906,1005,1006,1104,1203 (All sliding/fixed/louvre windows/doors)

As per plan, Medium colour

As per plan, Medium colour

As per plan, Medium colour Within apartments Bwtween apartment or to common

NFRC Glazing System (Glass+Frame) values: ⇒ U = 6.7 and SHGC = 0.70

(All sliding/fixed/louvre windows/doors) ⇒ U = 6.7 and SHGC = 0.57

Weather stripping fitted on windows

NFRC Glazing System (Glass+Frame) values: ⇒ U = 5.6 and SHGC = 0.41

⇒ U = 5.6 and SHGC = 0.36 (All awning/casement windows/doors)

NFRC Glazing System (Glass+Frame) values: ⇒ U = 5.4 and SHGC = 0.58

⇒ U = 5.4 and SHGC = 0.49

NFRC Glazing System (Glass+Frame) values: ⇒ U = 4.8 and SHGC = 0.59

 \Rightarrow U = 4.8 and SHGC = 0.51 (All awning/casement windows/doors)

NFRC Glazing System (Glass+Frame) values: ⇒ U = 4.3 and SHGC = 0.47

⇒ U = 4.3 and SHGC = 0.53 (All awning/casement windows/doors)

Tile (Bathroom, laundry and kitchen)
Timber (Living and bedroom)

Medium colour

TURNER

Weather stripping fitted on windows

To floor above unconditioned space

Weather stripping fitted on windows

Weather stripping fitted on windows

(All awning/casement windows/doors)

Weather stripping fitted on windows

(All awning/casement windows/doors)

DA-110-040

For DA Submission For Coordination For Coordination For Coordination For Coordination For Coordination

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HARBOUR DRIVE



15-31 Harbour Drive Harbour Drive Coffs Harbour State Postcode Country **GA Plans** Level 05

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02	11.11.20	BF	For Coordination	
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05	08.12.20	BF	For Coordination	
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For Information

TURNER

Basix Building Fabric Requirements

Aluminium frame, Single glazed, Clear Throughout, UNO

Colour back glass + R2.0 Insulation + PB

Aluminium frame, Single glazed, low solar gain Low-E

Aluminium frame, Single glazed, High solar gain Low-E

Aluminium frame, Double glazed, High solar gain Low-E

Concrete floor with R2.0 floor insulation

Concrete + R3.5 Insulation + PB

Exhaust fans All exhaust fans to have draft stoppers attached.

To units 101,201,202,203,301,302,303,401,402,403,708,1007 all windows/doors

Aluminium frame, Double glazed, Clear To unit 406 (kitchen/living only),409 ,508(kitchen/living only),607(kitchen/living only) 706(kitchen/living only),1204 all windows/doors

To units 505,604,703,704,705,803,804,903,904,1003,1004,1103 (All sliding/fixed/louvre windows/doors)

Double grazed, ringri solar gall. □

To unit
410,509,608,707,805,806,905,906,1005,1006,1104,1203
all windows/doors
□ U = 4.3 and SHGC = 0.47
(All sliding/fixed/louvre windows/doors)
□ U = 4.3 and SHGC = 0.53

Hebel+ R2.0 Insulation + PB

As per plan, Medium colour

As per plan, Medium colour

As per plan, Medium colour Within apartments

NFRC Glazing System (Glass+Frame) values: ⇒ U = 6.7 and SHGC = 0.70

(All sliding/fixed/louvre windows/doors) ⇒ U = 6.7 and SHGC = 0.57 (All awning/casement windows/doors)

NFRC Glazing System (Glass+Frame) values: ⇒ U = 5.6 and SHGC = 0.41

⇒ U = 5.6 and SHGC = 0.36 (All awning/casement windows/doors)

NFRC Glazing System (Glass+Frame) values: ⇒ U = 5.4 and SHGC = 0.58

 \Rightarrow U = 5.4 and SHGC = 0.49 (All awning/casement windows/doors)

NFRC Glazing System (Glass+Frame) values: ⇒ U = 4.8 and SHGC = 0.59

 \Rightarrow U = 4.8 and SHGC = 0.51 (All awning/casement windows/doors)

NFRC Glazing System (Glass+Frame) values: ⇒ U = 4.3 and SHGC = 0.47

(All awning/casement windows/doors)

Medium colour

Weather stripping fitted on windows

Weather stripping fitted on windows

To floor above unconditioned space

Tile (Bathroom, laundry and kitchen)
Timber (Living and bedroom)

Weather stripping fitted on windows

Weather stripping fitted on windows

Weather stripping fitted on windows

Bwtween apartment or to common

DLCS Quality Endorsed Company ISO 9001:2015, Registration Number 20476 Nominated Architect: Nicholas Turner 6695, ABN 86 064 084 911

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TURNER Rev



HARBOUR DRIVE



15-31 Harbour Drive Harbour Drive Coffs Harbour State Postcode Country **GA Plans** Level 06

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05 08.12.20 BF Fo	
06 11.12.20 BF Fo	For DA Submission

Basix Building Fabric Requirements

Aluminium frame, Single glazed, Clear Throughout, UNO

Colour back glass + R2.0 Insulation + PB

Hebel+ R2.0 Insulation + PB

Aluminium frame, Single glazed, low solar gain Low-E

Aluminium frame, Single glazed, High solar gain Low-E

Aluminium frame, Double glazed, High solar gain Low-E

Concrete floor with R2.0 floor insulation

Concrete + R3.5 Insulation + PB

Exhaust fans All exhaust fans to have draft stoppers attached.

To units 101,201,202,203,301,302,303,401,402,403,708,1007 all windows/doors

Aluminium frame, Double glazed, Clear To unit 406 (kitchen/living only),409 ,508(kitchen/living only),607(kitchen/living only) 706(kitchen/living only),1204 all windows/doors

To units 505,604,703,704,705,803,804,903,904,1003,1004,1103 (All sliding/fixed/louvre windows/doors)

Double grazed, ringri solar gall. □

To unit
410,509,608,707,805,806,905,906,1005,1006,1104,1203
all windows/doors
□ U = 4.3 and SHGC = 0.47
(All sliding/fixed/louvre windows/doors)
□ U = 4.3 and SHGC = 0.53

As per plan, Medium colour

As per plan, Medium colour

As per plan, Medium colour Within apartments

NFRC Glazing System (Glass+Frame) values: ⇒ U = 6.7 and SHGC = 0.70

(All sliding/fixed/louvre windows/doors) ⇒ U = 6.7 and SHGC = 0.57 (All awning/casement windows/doors)

Weather stripping fitted on windows

NFRC Glazing System (Glass+Frame) values: ⇒ U = 5.6 and SHGC = 0.41

⇒ U = 5.6 and SHGC = 0.36 (All awning/casement windows/doors)

NFRC Glazing System (Glass+Frame) values: ⇒ U = 5.4 and SHGC = 0.58

 \Rightarrow U = 5.4 and SHGC = 0.49 (All awning/casement windows/doors)

Weather stripping fitted on windows

NFRC Glazing System (Glass+Frame) values: ⇒ U = 4.8 and SHGC = 0.59

 \Rightarrow U = 4.8 and SHGC = 0.51 (All awning/casement windows/doors)

NFRC Glazing System (Glass+Frame) values: ⇒ U = 4.3 and SHGC = 0.47

(All awning/casement windows/doors)

Medium colour

Weather stripping fitted on windows

Weather stripping fitted on windows

To floor above unconditioned space

Tile (Bathroom, laundry and kitchen)
Timber (Living and bedroom)

Weather stripping fitted on windows

Bwtween apartment or to common

TURNER


DLCS Quality Endorsed Company ISO 9001:2015, Registration Number 20476 Nominated Architect: Nicholas Turner 6695, ABN 86 064 084 911

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HARBOUR DRIVE



15-31 Harbour Dr Harbour Drive Cof **GA Plans** Level 07

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02	11.11.20	BF	For Coordination		
03	20.11.20	BF	For Coordination		
04	01.12.20	BF	For Coordination		
05	08.12.20	BF	For Coordination		
06	11.12.20	BF	For DA Submission		

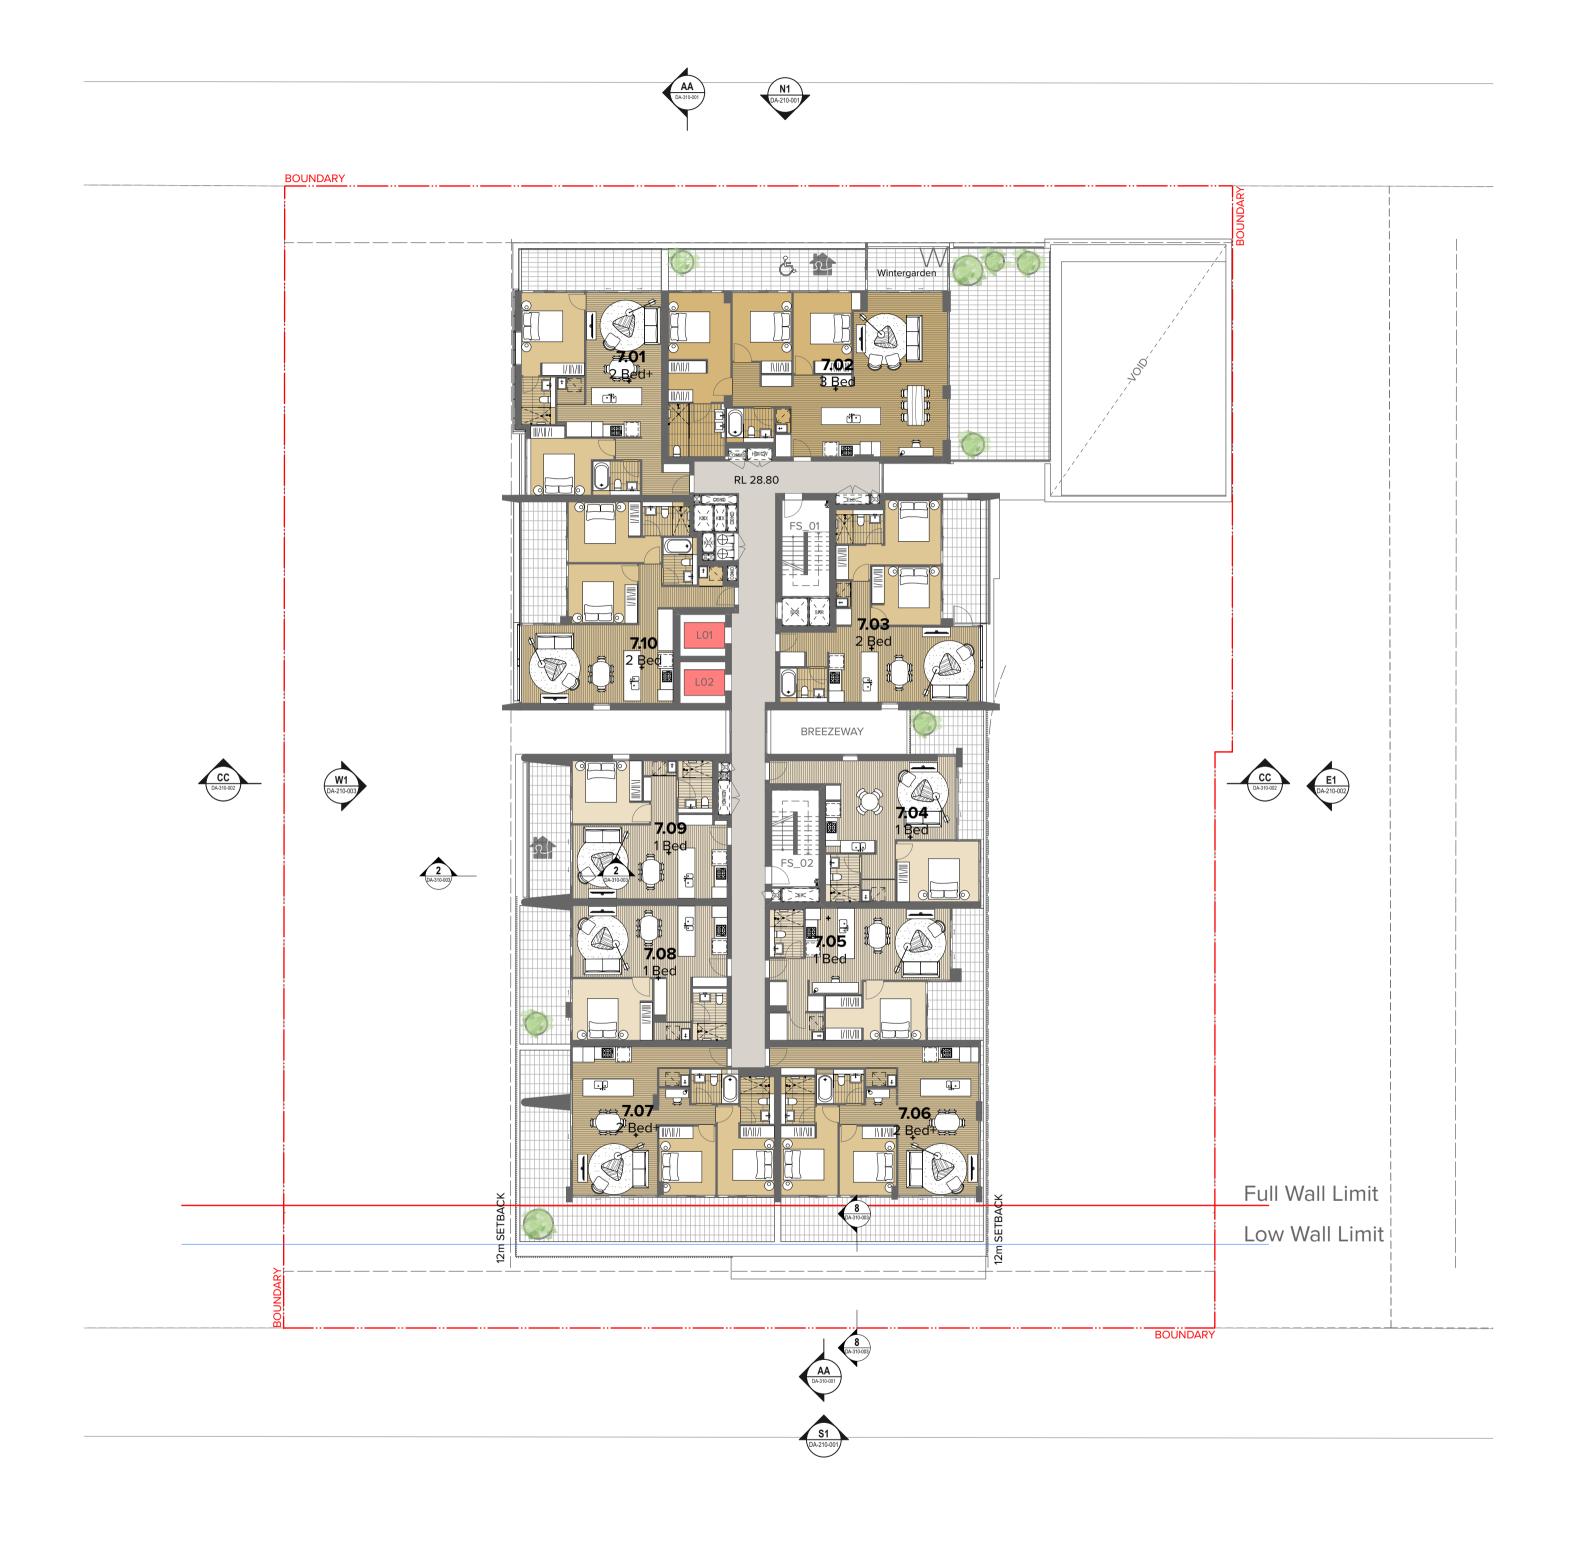Paynter Dixon

Level 2 2 Richardson Place Riverside

Corporate Park North Ryde NSW 2113

Basix Building Fabric Requirements

Aluminium frame, Single glazed, Clear Throughout, UNO

Colour back glass + R2.0 Insulation + PB

Aluminium frame, Single glazed, low solar gain Low-E

Aluminium frame, Single glazed, High solar gain Low-E

Aluminium frame, Double glazed, High solar gain Low-E

Concrete floor with R2.0 floor insulation

Exhaust fans All exhaust fans to have draft stoppers attached.

To units 101,201,202,203,301,302,303,401,402,403,708,1007 all windows/doors

Aluminium frame, Double glazed, Clear To unit 406 (kitchen/living only),409 ,508(kitchen/living only),607(kitchen/living only) 706(kitchen/living only),1204 all windows/doors

To units 505,604,703,704,705,803,804,903,904,1003,1004,1103 (All sliding/fixed/louvre windows/doors)

Double grazed, ringri solar gall. □

To unit
410,509,608,707,805,806,905,906,1005,1006,1104,1203
all windows/doors
□ U = 4.3 and SHGC = 0.47
(All sliding/fixed/louvre windows/doors)
□ U = 4.3 and SHGC = 0.53

Hebel+ R2.0 Insulation + PB

As per plan, Medium colour

As per plan, Medium colour

As per plan, Medium colour Within apartments

NFRC Glazing System (Glass+Frame) values: ⇒ U = 6.7 and SHGC = 0.70

⇒ 0 − 0.7 and SHGC − 0.70

(All sliding/fixed/louvre windows/doors)

⇒ U = 6.7 and SHGC = 0.57

(All awning/casement windows/doors)

NFRC Glazing System (Glass+Frame) values: ⇒ U = 5.6 and SHGC = 0.41

⇒ U = 5.6 and SHGC = 0.36 (All awning/casement windows/doors)

NFRC Glazing System (Glass+Frame) values: ⇒ U = 5.4 and SHGC = 0.58

 \Rightarrow U = 5.4 and SHGC = 0.49 (All awning/casement windows/doors)

NFRC Glazing System (Glass+Frame) values: ⇒ U = 4.8 and SHGC = 0.59

 \Rightarrow U = 4.8 and SHGC = 0.51 (All awning/casement windows/doors)

NFRC Glazing System (Glass+Frame) values: ⇒ U = 4.3 and SHGC = 0.47

(All awning/casement windows/doors)

Medium colour

Weather stripping fitted on windows

Weather stripping fitted on windows

To floor above unconditioned space

Tile (Bathroom, laundry and kitchen)
Timber (Living and bedroom)

Weather stripping fitted on windows

Weather stripping fitted on windows

Weather stripping fitted on windows

Bwtween apartment or to common



HARBOUR DRIVE

Level 08 1:200

15-31 Harbour Drive

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	02	11.11.20	BF	For Coordination			
	03	20.11.20	BF	For Coordination			
	04	01.12.20	BF	For Coordination			
	05	08.12.20	BF	For Coordination			

Basix Building Fabric Requirements

Aluminium frame, Single glazed, Clear Throughout, UNO

Colour back glass + R2.0 Insulation + PB

Hebel+ R2.0 Insulation + PB

Aluminium frame, Single glazed, low solar gain Low-E

Aluminium frame, Single glazed, High solar gain Low-E

Aluminium frame, Double glazed, High solar gain Low-E

Concrete floor with R2.0 floor insulation

Concrete + R3.5 Insulation + PB

Exhaust fans All exhaust fans to have draft stoppers attached.

06 11.12.20 BF For DA Submission

To units 101,201,202,203,301,302,303,401,402,403,708,1007 all windows/doors

Aluminium frame, Double glazed, Clear To unit 406 (kitchen/living only),409 ,508(kitchen/living only),607(kitchen/living only) 706(kitchen/living only),1204 all windows/doors

To units 505,604,703,704,705,803,804,903,904,1003,1004,1103 (All sliding/fixed/louvre windows/doors)

Double grazed, Fight Solar gall. □

To unit

410,509,608,707,805,806,905,906,1005,1006,1104,1203

all windows/doors

⇒ U = 4.3 and SHGC = 0.47

(All sliding/fixed/louvre windows/doors)

⇒ U = 4.3 and SHGC = 0.53

As per plan, Medium colour

As per plan, Medium colour

As per plan, Medium colour Within apartments

NFRC Glazing System (Glass+Frame) values: ⇒ U = 6.7 and SHGC = 0.70

(All sliding/fixed/louvre windows/doors) ⇒ U = 6.7 and SHGC = 0.57 (All awning/casement windows/doors)

Weather stripping fitted on windows

NFRC Glazing System (Glass+Frame) values: ⇒ U = 5.6 and SHGC = 0.41

⇒ U = 5.6 and SHGC = 0.36 (All awning/casement windows/doors)

NFRC Glazing System (Glass+Frame) values: ⇒ U = 5.4 and SHGC = 0.58

 \Rightarrow U = 5.4 and SHGC = 0.49 (All awning/casement windows/doors)

NFRC Glazing System (Glass+Frame) values: ⇒ U = 4.8 and SHGC = 0.59

 \Rightarrow U = 4.8 and SHGC = 0.51 (All awning/casement windows/doors)

NFRC Glazing System (Glass+Frame) values: ⇒ U = 4.3 and SHGC = 0.47

(All awning/casement windows/doors)

Medium colour

Weather stripping fitted on windows

Weather stripping fitted on windows

To floor above unconditioned space

Tile (Bathroom, laundry and kitchen)
Timber (Living and bedroom)

Weather stripping fitted on windows

Weather stripping fitted on windows

Bwtween apartment or to common

TURNER

TURNER

DLCS Quality Endorsed Company ISO 9001:2015, Registration Number 20476 Nominated Architect: Nicholas Turner 6695, ABN 86 064 084 911

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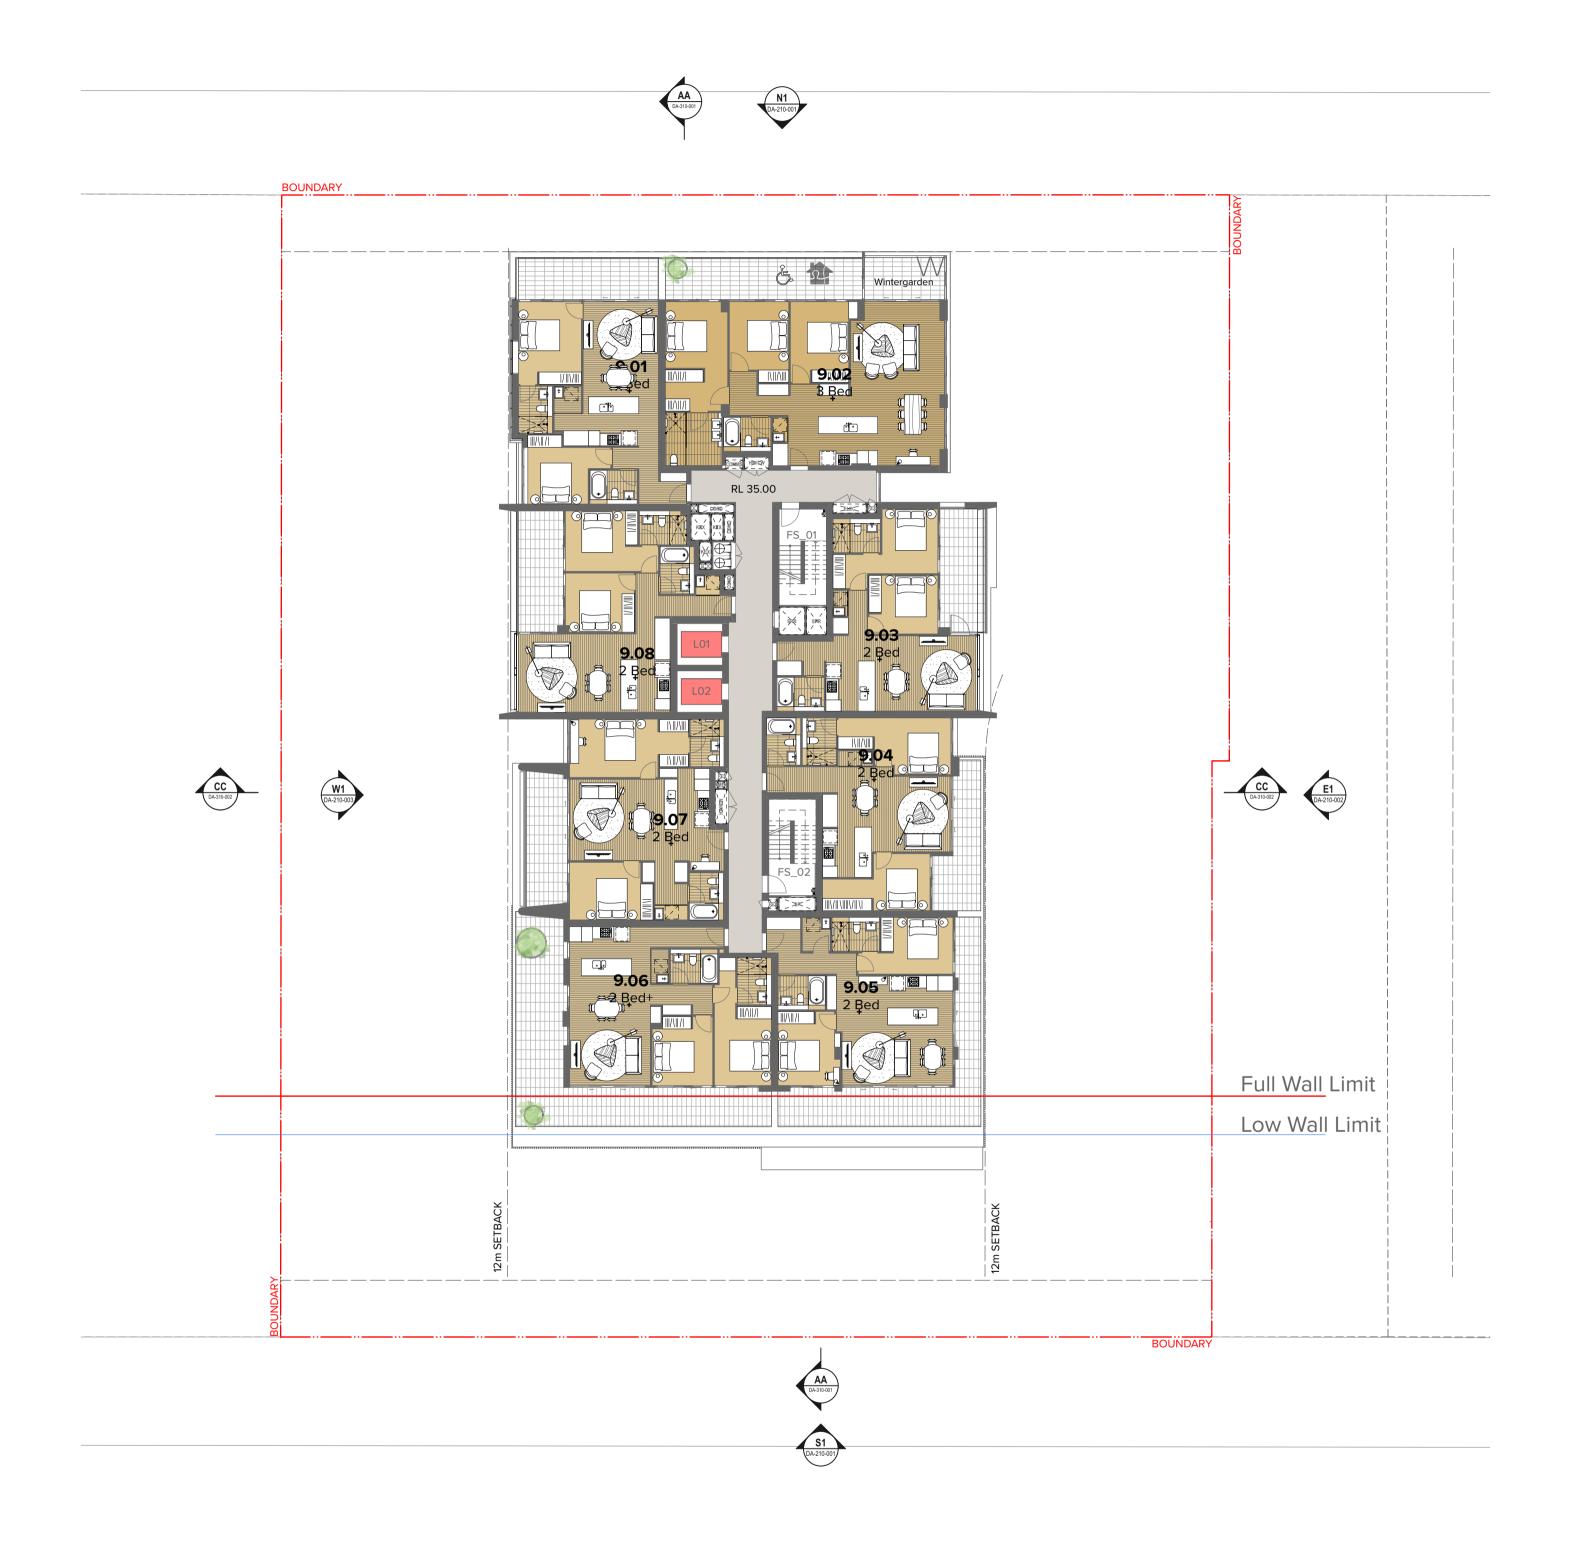
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Level 2 2 Richardson Place Riverside

Corporate Park North Ryde NSW 2113

Harbour Drive Coffs Harbour State Postcode Country **GA Plans**

Level 08



HARBOUR DRIVE



15-31 Harbour Drive Harbour Drive Coffs Harbour S **GA Plans** Level 09

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For DA Submission For Coordination For Coordination

For Coordination

06 11.12.20 05 08.12.20 04 01.12.20

Basix Building Fabric Requirements

Aluminium frame, Single glazed, Clear Throughout, UNO

Colour back glass + R2.0 Insulation + PB

Hebel+ R2.0 Insulation + PB

Aluminium frame, Single glazed, low solar gain Low-E

Aluminium frame, Single glazed, High solar gain Low-E

Aluminium frame, Double glazed, High solar gain Low-E

Concrete floor with R2.0 floor insulation

Concrete + R3.5 Insulation + PB

Exhaust fans All exhaust fans to have draft stoppers attached.

To units 101,201,202,203,301,302,303,401,402,403,708,1007 all windows/doors

Aluminium frame, Double glazed, Clear To unit 406 (kitchen/living only),409 ,508(kitchen/living only),607(kitchen/living only) 706(kitchen/living only),1204 all windows/doors

To units 505,604,703,704,705,803,804,903,904,1003,1004,1103 (All sliding/fixed/louvre windows/doors)

Double grazed, ringri solar gall. □

To unit
410,509,608,707,805,806,905,906,1005,1006,1104,1203
all windows/doors
□ U = 4.3 and SHGC = 0.47
(All sliding/fixed/louvre windows/doors)
□ U = 4.3 and SHGC = 0.53

As per plan, Medium colour

As per plan, Medium colour

As per plan, Medium colour Within apartments

NFRC Glazing System (Glass+Frame) values: ⇒ U = 6.7 and SHGC = 0.70

(All sliding/fixed/louvre windows/doors) ⇒ U = 6.7 and SHGC = 0.57

Weather stripping fitted on windows

NFRC Glazing System (Glass+Frame) values: ⇒ U = 5.6 and SHGC = 0.41

⇒ U = 5.6 and SHGC = 0.36 (All awning/casement windows/doors)

NFRC Glazing System (Glass+Frame) values: ⇒ U = 5.4 and SHGC = 0.58

 \Rightarrow U = 5.4 and SHGC = 0.49 (All awning/casement windows/doors)

Weather stripping fitted on windows

NFRC Glazing System (Glass+Frame) values: ⇒ U = 4.8 and SHGC = 0.59

 \Rightarrow U = 4.8 and SHGC = 0.51 (All awning/casement windows/doors)

NFRC Glazing System (Glass+Frame) values: ⇒ U = 4.3 and SHGC = 0.47

(All awning/casement windows/doors)

Medium colour

Weather stripping fitted on windows

Weather stripping fitted on windows

To floor above unconditioned space

Tile (Bathroom, laundry and kitchen)
Timber (Living and bedroom)

Weather stripping fitted on windows

(All awning/casement windows/doors)

Bwtween apartment or to common

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Level 2 2 Richardson Place Riverside



HARBOUR DRIVE

Level 10 1:200

15-31 Harbour Drive Harbour Drive Coffs Harbour State Postcode **GA Plans** Level 10

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Rev	Date	Approved by	Revision Notes	
01	29.10.20	BF	For Coordination	
02	11.11.20	BF	For Coordination	
03	20.11.20	BF	For Coordination	
04	01.12.20	BF	For Coordination	
05	08.12.20	BF	For Coordination	
06	11.12.20	BF	For DA Submission	

Basix Building Fabric Requirements

Aluminium frame, Single glazed, Clear Throughout, UNO

Colour back glass + R2.0 Insulation + PB

Aluminium frame, Single glazed, low solar gain Low-E

Aluminium frame, Single glazed, High solar gain Low-E

Aluminium frame, Double glazed, High solar gain Low-E

Concrete floor with R2.0 floor insulation

Exhaust fans All exhaust fans to have draft stoppers attached.

To units 101,201,202,203,301,302,303,401,402,403,708,1007 all windows/doors

Aluminium frame, Double glazed, Clear To unit 406 (kitchen/living only),409 ,508(kitchen/living only),607(kitchen/living only) 706(kitchen/living only),1204 all windows/doors

Double grazed, ringin solar gall. □

To unit 410,509,608,707,805,806,905,906,1005,1006,1104,1203 all windows/doors

⇒ U = 4.3 and SHGC = 0.47 (All sliding/fixed/louvre windows/doors)

⇒ U = 4.3 and SHGC = 0.53

Hebel+ R2.0 Insulation + PB

As per plan, Medium colour

As per plan, Medium colour

As per plan, Medium colour Within apartments

NFRC Glazing System (Glass+Frame) values: ⇒ U = 6.7 and SHGC = 0.70

⇒ 0 − 0.7 and SHGC − 0.70

(All sliding/fixed/louvre windows/doors)

⇒ U = 6.7 and SHGC = 0.57

(All awning/casement windows/doors)

NFRC Glazing System (Glass+Frame) values: ⇒ U = 5.6 and SHGC = 0.41

⇒ U = 5.6 and SHGC = 0.36 (All awning/casement windows/doors)

NFRC Glazing System (Glass+Frame) values: ⇒ U = 5.4 and SHGC = 0.58

 \Rightarrow U = 5.4 and SHGC = 0.49 (All awning/casement windows/doors)

NFRC Glazing System (Glass+Frame) values: ⇒ U = 4.8 and SHGC = 0.59

 \Rightarrow U = 4.8 and SHGC = 0.51 (All awning/casement windows/doors)

NFRC Glazing System (Glass+Frame) values: ⇒ U = 4.3 and SHGC = 0.47

(All awning/casement windows/doors)

Medium colour

Weather stripping fitted on windows

Weather stripping fitted on windows

To floor above unconditioned space

Tile (Bathroom, laundry and kitchen)
Timber (Living and bedroom)

Weather stripping fitted on windows

Weather stripping fitted on windows

Weather stripping fitted on windows

Bwtween apartment or to common

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HARBOUR DRIVE



15-31 Ha Harbour Drawing Title **GA Plans** Level 11

	02	1
	01	2
	Rev	D
	Scale	
larbour Drive	1:200), 1
r Drive Coffs Harbour State Postcode Country		
I Drive Colls Harbour State Postcode Country		nfc

For Information			DA-110-110	06	
Status			Dwg No.	Rev	- 1
1:200), 1:1.64 @	A1, 50%@A3	20023	TURNER	5
Scale		F	Project No.	Drawn by	North
Rev	Date	Approved by	Revision Notes		
01	29.10.20	BF	For Coordination		
02	11.11.20	BF	For Coordination		
03	20.11.20	BF	For Coordination		
04	01.12.20	BF	For Coordination		
05	08.12.20	BF	For Coordination		
06	11.12.20	BF	For DA Submission		

Basix Building Fabric Requirements

Aluminium frame, Single glazed, Clear Throughout, UNO

Colour back glass + R2.0 Insulation + PB

Hebel+ R2.0 Insulation + PB

Aluminium frame, Single glazed, low solar gain Low-E

Aluminium frame, Single glazed, High solar gain Low-E

Aluminium frame, Double glazed, High solar gain Low-E

Concrete floor with R2.0 floor insulation

Concrete + R3.5 Insulation + PB

Exhaust fans All exhaust fans to have draft stoppers attached.

To units 101,201,202,203,301,302,303,401,402,403,708,1007 all windows/doors

Aluminium frame, Double glazed, Clear To unit 406 (kitchen/living only),409 ,508(kitchen/living only),607(kitchen/living only) 706(kitchen/living only),1204 all windows/doors

Double grazed, ringin solar gall. □

To unit 410,509,608,707,805,806,905,906,1005,1006,1104,1203 all windows/doors

⇒ U = 4.3 and SHGC = 0.47 (All sliding/fixed/louvre windows/doors)

⇒ U = 4.3 and SHGC = 0.53

As per plan, Medium colour

As per plan, Medium colour

As per plan, Medium colour Within apartments

NFRC Glazing System
(Glass+Frame) values:

⇒ U = 6.7 and SHGC = 0.70
(All sliding/fixed/louvre
windows/doors)

⇒ U = 6.7 and SHGC = 0.57
(All awning/casement
windows/doors)

Weather stripping fitted on windows

NFRC Glazing System (Glass+Frame) values: ⇒ U = 5.6 and SHGC = 0.41

⇒ U = 5.6 and SHGC = 0.36 (All awning/casement windows/doors)

NFRC Glazing System (Glass+Frame) values: ⇒ U = 5.4 and SHGC = 0.58

 \Rightarrow U = 5.4 and SHGC = 0.49 (All awning/casement windows/doors)

NFRC Glazing System (Glass+Frame) values: ⇒ U = 4.8 and SHGC = 0.59

 \Rightarrow U = 4.8 and SHGC = 0.51 (All awning/casement windows/doors)

NFRC Glazing System (Glass+Frame) values: ⇒ U = 4.3 and SHGC = 0.47

(All awning/casement windows/doors)

Medium colour

Weather stripping fitted on windows

Weather stripping fitted on windows

To floor above unconditioned space

Tile (Bathroom, laundry and kitchen)
Timber (Living and bedroom)


Weather stripping fitted on windows

Weather stripping fitted on windows

Bwtween apartment or to common

Paynter Dixon

Level 2 2 Richardson Place Riverside

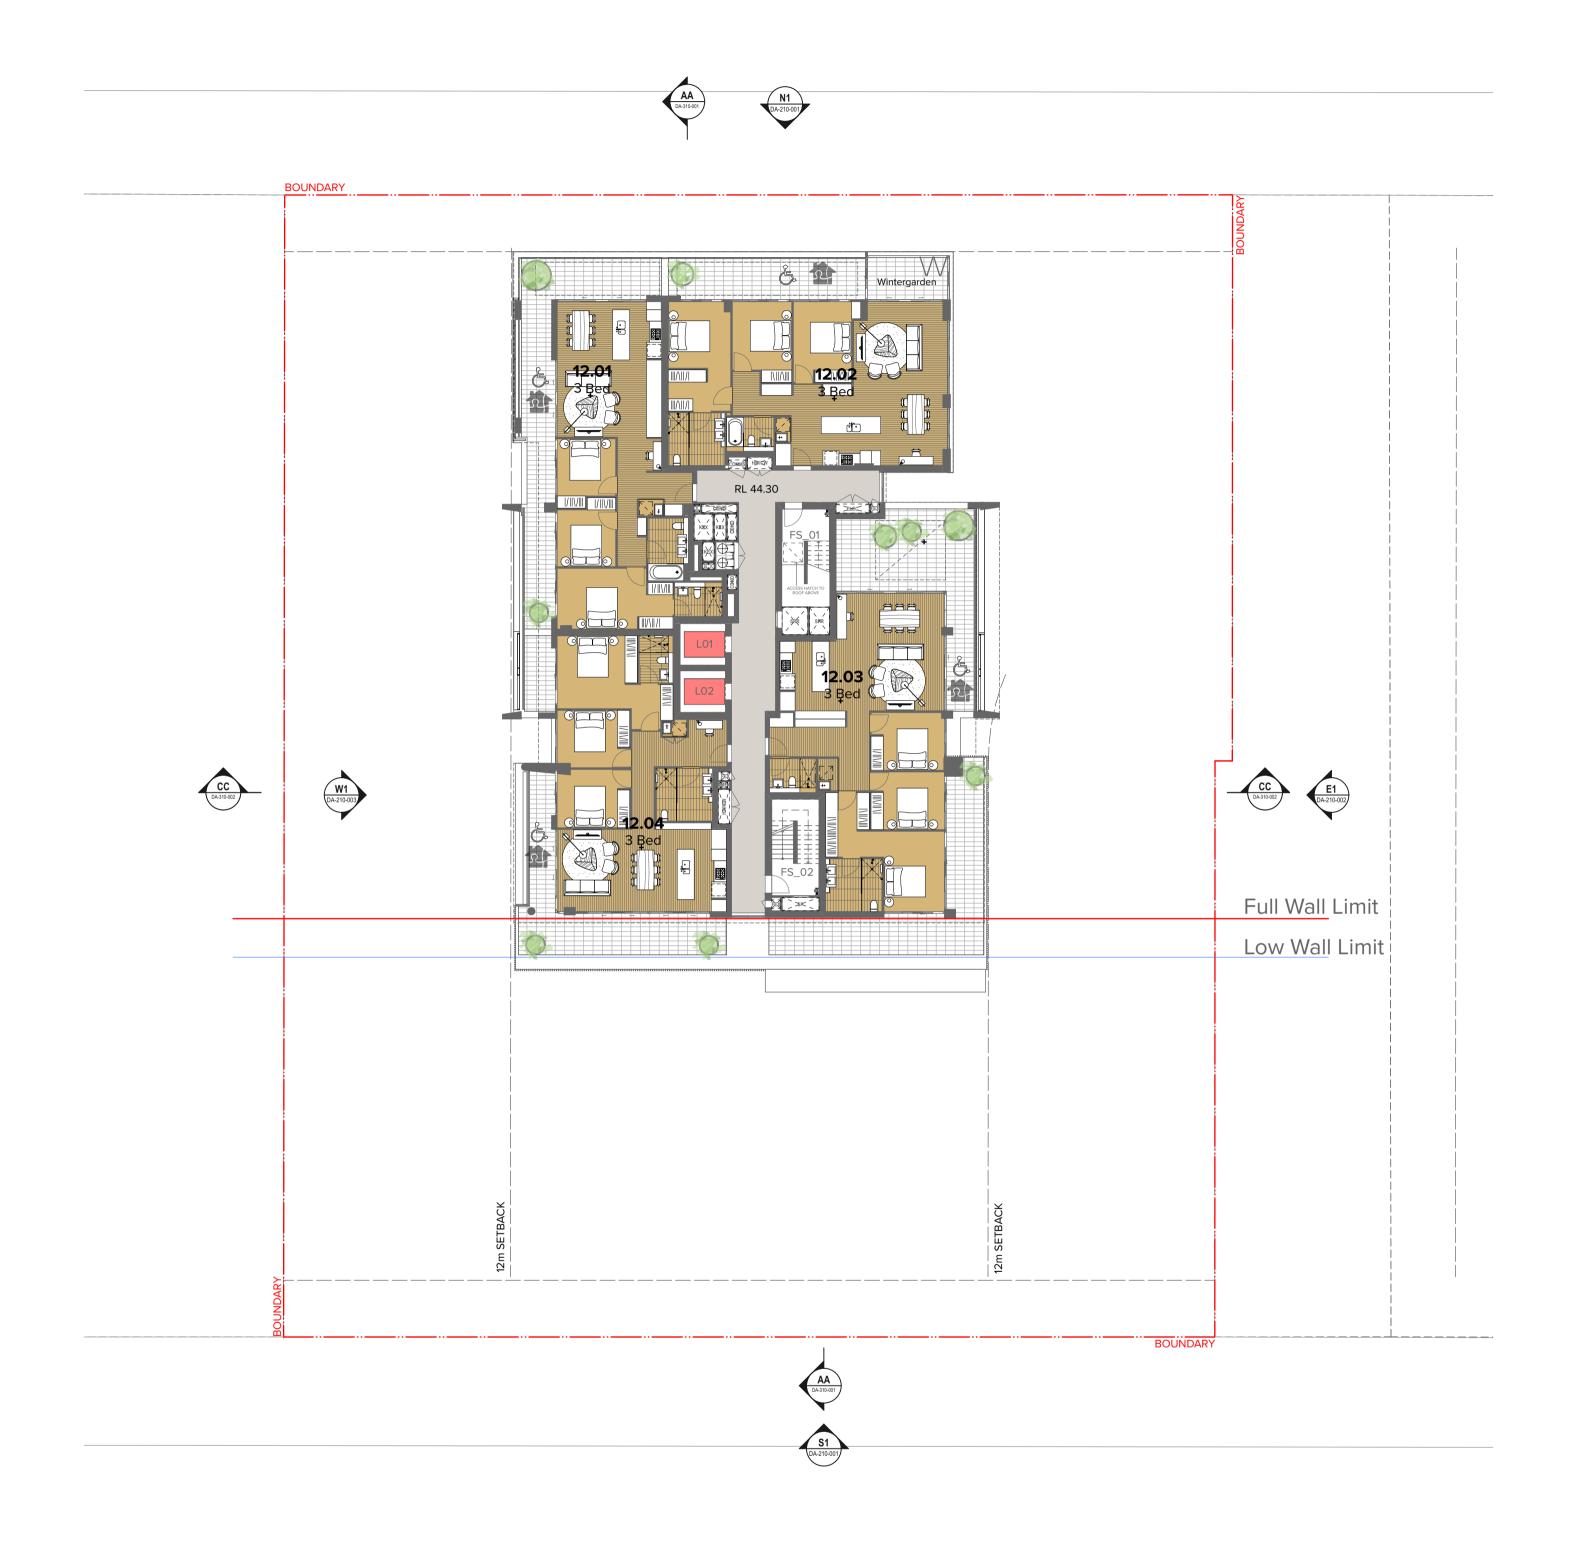

HARBOUR DRIVE



15-31 Harbour Drive Harbour Drive Coffs Harb **GA Plans** Level 12

Total State Footbode Scarray	For I	nformation	1	DA-11
rbour State Postcode Country	Status		I	Dwg No.
	1:200	0, 1:1.64 @	A1, 50%@A3	
	Scale		I	Project No.
	Rev	Date	Approved by	Revision Notes
	01	29.10.20	BF	For Coordination
	02	11.11.20	BF	For Coordination
	03	20.11.20	BF	For Coordination

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Paynter Dixon

Level 2 2 Richardson Place Riverside

Corporate Park North Ryde NSW 2113

DLCS Quality Endorsed Company ISO 9001:2015, Registration Number 20476 Nominated Architect: Nicholas Turner 6695, ABN 86 064 084 911

For DA Submission For Coordination For Coordination

Dwg No. **DA-110-120**

Basix Building Fabric Requirements

Aluminium frame, Single glazed, Clear Throughout, UNO

Colour back glass + R2.0 Insulation + PB

Hebel+ R2.0 Insulation + PB

Aluminium frame, Single glazed, low solar gain Low-E

Aluminium frame, Single glazed, High solar gain Low-E

Aluminium frame, Double glazed, High solar gain Low-E

Concrete floor with R2.0 floor insulation

Concrete + R3.5 Insulation + PB

Exhaust fans All exhaust fans to have draft stoppers attached.

06 11.12.20 05 08.12.20 04 01.12.20

To units 101,201,202,203,301,302,303,401,402,403,708,1007 all windows/doors

Aluminium frame, Double glazed, Clear To unit 406 (kitchen/living only),409 ,508(kitchen/living only),607(kitchen/living only) 706(kitchen/living only),1204 all windows/doors

Double grazed, ringin solar gall. □

To unit 410,509,608,707,805,806,905,906,1005,1006,1104,1203 all windows/doors

⇒ U = 4.3 and SHGC = 0.47 (All sliding/fixed/louvre windows/doors)

⇒ U = 4.3 and SHGC = 0.53

TURNER Rev

As per plan, Medium colour

As per plan, Medium colour

As per plan, Medium colour Within apartments

NFRC Glazing System (Glass+Frame) values: ⇒ U = 6.7 and SHGC = 0.70

(All sliding/fixed/louvre windows/doors) ⇒ U = 6.7 and SHGC = 0.57 (All awning/casement windows/doors)

NFRC Glazing System (Glass+Frame) values: ⇒ U = 5.6 and SHGC = 0.41

⇒ U = 5.6 and SHGC = 0.36 (All awning/casement windows/doors)

NFRC Glazing System (Glass+Frame) values: ⇒ U = 5.4 and SHGC = 0.58

 \Rightarrow U = 5.4 and SHGC = 0.49 (All awning/casement windows/doors)

NFRC Glazing System (Glass+Frame) values: ⇒ U = 4.8 and SHGC = 0.59

 \Rightarrow U = 4.8 and SHGC = 0.51 (All awning/casement windows/doors)

NFRC Glazing System (Glass+Frame) values: ⇒ U = 4.3 and SHGC = 0.47

(All awning/casement windows/doors)

Medium colour

Weather stripping fitted on windows

Weather stripping fitted on windows

To floor above unconditioned space


Tile (Bathroom, laundry and kitchen)
Timber (Living and bedroom)

Weather stripping fitted on windows

Weather stripping fitted on windows

Weather stripping fitted on windows

Bwtween apartment or to common

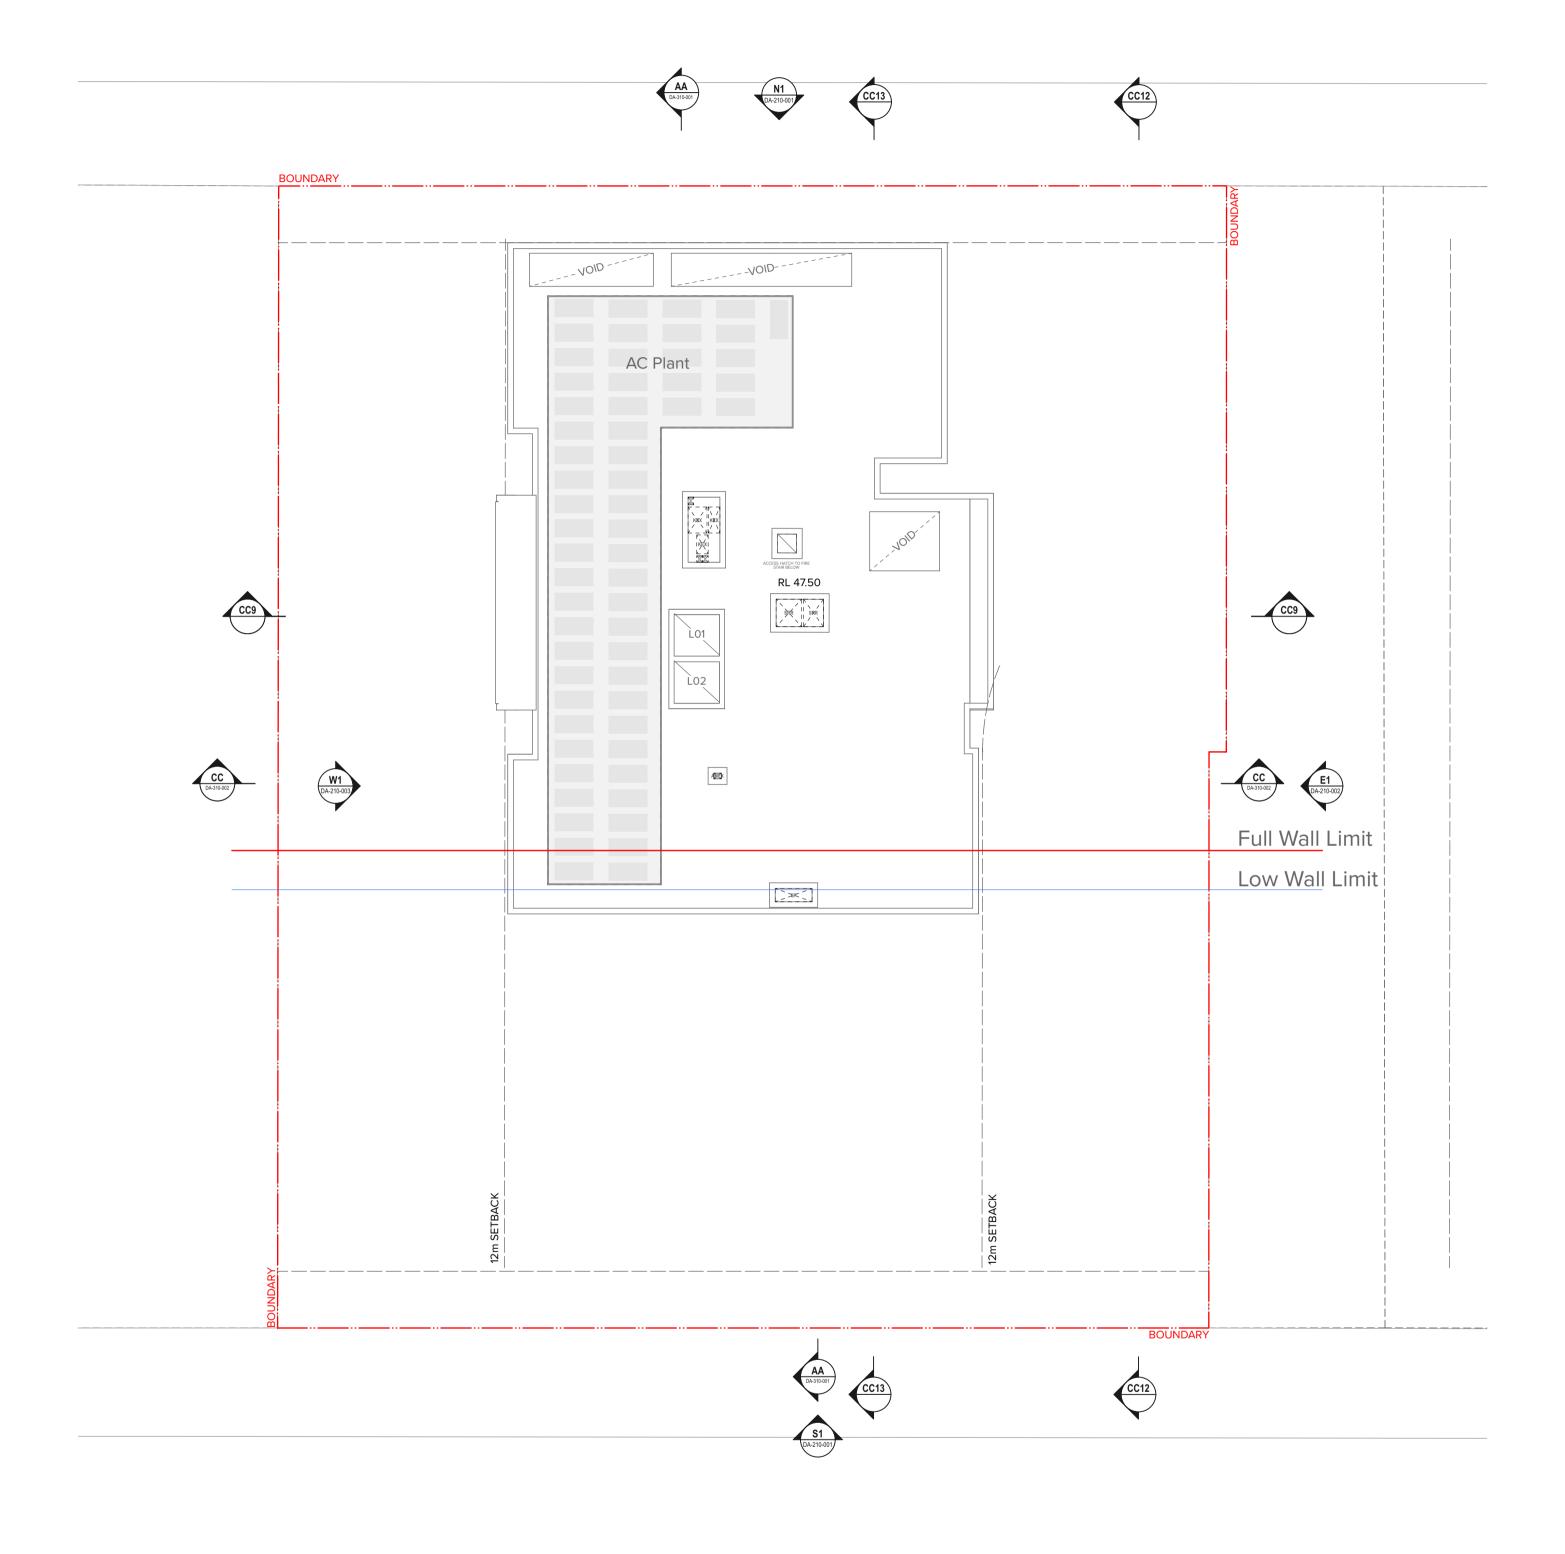

HARBOUR DRIVE



15-31 Harbour Drive Harbour Drive Coffs Harbour State Postcode Country Drawing Title **GA Plans**

٠,	For In	For Information DA-110					
ry	Status		D	Dwg No.			
	1:200	, 1:1.64 @	A1, 50%@A3_		20023		
	Scale		Р	roject No.			
	Rev	Date	Approved by	Revision Notes			
	01	29.10.20	BF	For Coordination			
	02	11.11.20	BF	For Coordination			
	03	20.11.20	BF	For Coordination			
	04	27.11.20	BF	For Coordination			
	05	01.12.20	BF	For Coordination			
	06	08.12.20	BF	For Coordination			
	07	11.12.20	DF	FOI DA SUDMISSIO	I)		

Basix Building Fabric Requirements

Internal walls Plasterboard on stud

Aluminium frame, Single glazed, Clear Throughout, UNO

Colour back glass + R2.0 Insulation + PB

Hebel+ R2.0 Insulation + PB

Aluminium frame, Single glazed, low solar gain Low-E

Aluminium frame, Single glazed, High solar gain Low-E

Aluminium frame, Double glazed, High solar gain Low-E

Concrete floor with R2.0 floor insulation

Exhaust fans All exhaust fans to have draft stoppers attached.

Aluminium frame, Double glazed, Clear

To units 101,201,202,203,301,302,303,401,402,403,708,1007

To unit 406 (kitchen/living only),409 ,508(kitchen/living only),607(kitchen/living only) 706(kitchen/living only),1204 all windows/doors

To units 505,604,703,704,705,803,804,903,904,1003,1004,1103 (All sliding/fixed/louvre windows/doors)

To unit \Rightarrow U = 4.3 and SHGC = 0 410,509,608,707,805,806,905,906,1005,1006,1104,1203 (All sliding/fixed/louvre windows/doors)

As per plan, Medium colour

As per plan, Medium colour

As per plan, Medium colour

NFRC Glazing System (Glass+Frame) values: ⇒ U = 6.7 and SHGC = 0.70

Weather stripping fitted on windows

NFRC Glazing System (Glass+Frame) values: ⇒ U = 5.6 and SHGC = 0.41

⇒ U = 5.6 and SHGC = 0.36 (All awning/casement windows/doors)

NFRC Glazing System (Glass+Frame) values: ⇒ U = 5.4 and SHGC = 0.58

⇒ U = 5.4 and SHGC = 0.49 (All awning/casement windows/doors)

NFRC Glazing System (Glass+Frame) values: ⇒ U = 4.8 and SHGC = 0.59

 \Rightarrow U = 4.8 and SHGC = 0.51 (All awning/casement windows/doors)

⇒ U = 4.3 and SHGC = 0.53 (All awning/casement windows/doors)

Tile (Bathroom, laundry and kitchen)
Timber (Living and bedroom)

Medium colour

Weather stripping fitted on windows

To floor above unconditioned space

Weather stripping fitted on windows NFRC Glazing System (Glass+Frame) values: ⇒ U = 4.3 and SHGC = 0.47

Weather stripping fitted on windows

Weather stripping fitted on windows

(All sliding/fixed/louvre windows/doors) \Rightarrow U = 6.7 and SHGC = 0.57 (All awning/casement windows/doors)

Within apartments Bwtween apartment or to common

Paynter Dixon Level 2 2 Richardson Place Riverside Corporate Park North Ryde NSW 2113

TURNER

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Paynter Dixon
Level 2 2 Richardson Place Riverside
Corporate Park North Ryde NSW 2113

Project Title

15-31 Harbour Drive
Harbour Drive Coffs Harbour State Postcode Country

Drawing Title

Sections
Section 01

 02
 11.12.20
 BF
 For DA Submission

 01
 11.11.20
 BF
 For Coordination

 Rev
 Date
 Approved by
 Revision Notes

 Scale
 Project No.
 Drawn by
 North

 1:200 @A1, 50%@A3
 20023
 TURNER

 Status
 Dwg No.
 Rev

 DA-310-001
 02



DLCS Quality Endorsed Company ISO 9001:2015, Registration Number 20476 Nominated Architect: Nicholas Turner 6695, ABN 86 064 084 911

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CLIENT

Paynter Dixon

Level 2 2 Richardson Place Riverside

Corporate Park North Ryde NSW 2113

ide 2113

Project Title

15-31 Harbour Drive
Harbour Drive Coffs Harbour State Postcode Country

Drawing Title

Sections
Section 02

 02
 11.12.20
 BF
 For DA Submission

 01
 11.11.20
 BF
 For Coordination

 Rev
 Date
 Approved by
 Revision Notes

 Scale
 Project No.
 Drawn by
 North

 1:200 @A1, 50%@A3
 20023
 TURNER
 Rev

 Status
 Dwg No.
 Rev
 DM-310-002
 02

		BOUNDARY		9m SEPARATION						L	OH SEPAKATION	- BOUNDARY
	44m DCP HEIGHT C Roof Level RL47.500				yParapet RL48.700	↓Lift C	Overrun 8.700	ROOF PLANT			. — — — — — — — —	
FUTURE CONTEXT	RL47.500 Level 12 RL44.300	3,200			BY	3 BED	COR	3 BED	ВУ			FUTURE CONTEXT
	RL44.300 Level 11 RL41.200	3,100			BY	2 BED	c (iii)	2 BED	ВУ			
	RL41.200	3,600 3,100 3,100 3,100 3,100 3,100 3,100			ВУ	1 BED	COR	2 BED	BY			
	RL38.100 Level 09 RL35.000	3,100			} B\ (v)	2 BED	COR	2 BED	ВУ			
	RL35.000 Level 08 RL31.900	3,100			BY	2 BED	COR	1BED	ВУ			
	Level 07	3,100			BY	1 BED	COR	1BED	ВУ			
	Level 06	3,100			ВУ	1 BED	COR	1 BED		BY		
	Level 05 RL22.600	3,100			BY	1 BED	COR	1 BED		BY	COMMUNAL PODIUM	
	Level 04 RL19.500	3,100		}	TCE	1 BED	COR	1BED		TCE	PODIUM	
	Level 03 RL15.900					RESI PARKING						
	RL15.900 Level 02 RL12.800	3,100				RESI PARKING						
		3,100	000000000000000000000000000000000000000			RETAIL + RESI PARKING						
	▼Level 01 RL9.800 Mezzanine Lev	el 00 (2,500)				Service Zone RTL_03	El	LEC II	 ===	=====	-==	
	Ground Level ŘL4.700	5,500			WWW	▼ RL 5.300	RO			RETAIL PARKING	▼ RL 4.700	
												x



DLCS Quality Endorsed Company ISO 9001:2015, Registration Number 20476 Nominated Architect: Nicholas Turner 6695, ABN 86 064 084 911

Sections **Section Details**





Balustrade Type 3
Semi-frameless full height opaque glass.
PF3 Metal baluster fixed to slab

Materials Legend:

Slab front fixed. Colour to match PF1.

BAL2 Balustrade Type 2
Semi-Frameless opaque glass fixed to concrete upturn balustrade

Balustrade Type 4
Horizontal balusters fixed to concrete upturn.
COF1 finish.

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Brickwork Pattern Type 1
Stretcher Bond Austral Bowral Dry Pressed Brick Balustrade Type 1 Vertical 100 x 20 metal baluster, no top rail. Colour to match "Simmental Silver"

Paynter Dixon

Level 2 2 Richardson Place Riverside

Corporate Park North Ryde NSW 2113

Brickwork Pattern Type 2
Perforated screening similar to Austral breeze-block

Residential Glazing with PF3 framing (Refer to BASIX for glass requirement)

GC5 Colourback Glazing with PF1 framing (Refer to BASIX for glass requirement)

Retail Glazing with PF3 framing

(GC1) Retail Glazing with אונה פרבי (Refer to Section J for glass requirement)

GC2 Residential Glazing with PF1 framing (Refer to BASIX for glass requirement)

GC3 Residential Glazing with PF2 framing (Refer to BASIX for glass requirement)

GC6 Colourback Glazing with PF2 framing (Refer to BASIX for glass requirement)

Louvre Type 1
Operable Glass Louvre Window with PF1 framing

COF1
Concrete Off Form 1
Smooth off form concrete.
Penetrating clear matte sea

Louvre Type 2 Operable Glass Louvre Window with PF3 framing

Louvre Type 3 Fixed Horizontal Louvre System to plantrooms.

PF2 Paint Finish Type 2
Paint finish to match Dulux "Natural White" or equivalent powdercoat finish where applicable

PF1 Paint Finish Type 1
Paint finish - light bronze or equivalent

powdercoat finish where applicable

PLT1 Planter Type 1 GRC Planter

(AW1) Awning with PF2 finish

Paint Finish Type 3
Paint finish to match Dulux "Monument" or equivalent powdercoat finish where applicable SCN1 Screen Type 1
Bifold glazing. PF1 finish.

SCN2 Screen Type 2
Bifold glazing. PF2 finish.

SCN3 Screen Type 3
Aluminium plant screen.
PF3 finish.

SCN4 Screen Type 4 Aluminium plant screen. PF1 finish.

15-31 Harbour Drive Drawing Title

Harbour Drive Coffs Harbour State Postcode Country

Elevations East Elevation

TURNER

Basix Building Fabric Requirements

Single glazed, Clear

Throughout, UNO

Aluminium frame,

Aluminium frame,

Aluminium frame, Double glazed, Clear

Aluminium frame,

Concrete floor

Downlights All LED downlights

02 11.12.20

For Information

01 01.12.20

Single glazed, low solar gain Low-E

Single glazed, High solar gain Low-E

To units 101,201,202,203,301,302,303,401,402,403,708,1007

To unit 406 (kitchen/living only),409 ,508(kitchen/living

only),607(kitchen/living only) 706(kitchen/living only),1204 all windows/doors

Double glazed, High solar gain Low-E

Concrete floor with R2.0 floor insulation

Concrete + R3.5 Insulation + PB

Exhaust fans All exhaust fans to have draft stoppers attached.

Rev Date Approved by Revision Notes

1:200, 1:100, 1:1.64 @A1, 50%@A3

To units 505,604,703,704,705,803,804,903,904,1003,1004,1103 (All sliding/fixed/louvre windows/doors) (All sliding/fixed/louvre windows/doors)

To unit 410,509,608,707,805,806,905,906,1005,1006,1104,1203 (All sliding/fixed/louvre windows/doors windows/doors)

For DA Submission

BF For Coordination

Colour back glass + R2.0 Insulation + PE

Hebel+ R2.0 Insulation + PB

Hebel + Acoustic Insulation +PB

Element Material Type

Internal walls Plasterboard on stud

20023

DA-210-002

As per plan, Medium colour

As per plan, Medium colour

As per plan, Medium colour

⇒ U = 6.7 and SHGC = 0.70

(All sliding/fixed/louvre windows/doors)

⇒ U = 6.7 and SHGC = 0.57

Weather stripping fitted on windows

Within apartments

NFRC Glazing System (Glass+Frame) values:

(All awning/casement windows/doors)

NFRC Glazing System (Glass+Frame) values:

⇒ U = 5.6 and SHGC = 0.41

(All sliding/fixed/louvre windows/doors) ⇒ U = 5.6 and SHGC = 0.36 (All awning/casement windows/doors)

NFRC Glazing System (Glass+Frame) values:

⇒ U = 5.4 and SHGC = 0.58

 \Rightarrow U = 5.4 and SHGC = 0.49

NFRC Glazing System (Glass+Frame) values: ⇒ U = 4.8 and SHGC = 0.59

(All sliding/fixed/louvre windows/doors)

(All awning/casement windows/doors)

NFRC Glazing System (Glass+Frame) values:

⇒ U = 4.3 and SHGC = 0.47

 \Rightarrow U = 4.3 and SHGC = 0.53

Weather stripping fitted on windows

All downlights comply with AS60598 IC-F Rating.

TURNER

02

Tile (Bathroom, laundry and Timber (Living and bedroom) To floor above unconditioned space

(All awning/casement windows/doors)

Medium colour

⇒ U = 4.8 and SHGC = 0.51

DLCS Quality Endorsed Company ISO 9001:2015, Registration Number 20476 Nominated Architect: Nicholas Turner 6695, ABN 86 064 084 911



powdercoat finish where applicable

PF2 Paint Finish Type 2
Paint finish to match Dulux "Natural White" or

Paint Finish Type 3
Paint finish to match Dulux "Monument" or

equivalent powdercoat finish where applicable

equivalent powdercoat finish where applicable

(AW1) Awning with PF2 finish

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Slab front fixed. Colour to match PF1.

BAL2 Balustrade Type 2
Semi-Frameless opaque glass fixed to concrete upturn balustrade

Balustrade Type 3
Semi-frameless full height opaque glass.
PF3 Metal baluster fixed to slab

Balustrade Type 4
Horizontal balusters fixed to concrete upturn.
COF1 finish.

Paynter Dixon Level 2 2 Richardson Place Riverside

GC2 Residential Glazing with PF1 framing (Refer to BASIX for glass requirement)

Residential Glazing with PF2 framing (Refer to BASIX for glass requirement)

Residential Glazing with PF3 framing (Refer to BASIX for glass requirement)

GC5 Colourback Glazing with PF1 framing (Refer to BASIX for glass requirement)

GC6 Colourback Glazing with PF2 framing (Refer to BASIX for glass requirement)

Colour to match "Simmental Silver"

BWK2 Brickwork Pattern Type 2
Perforated screening similar to Austral

breeze-block

15-31 Harbour Drive Harbour Drive Coffs Harbour State Postcode Country Drawing Title **Elevations West Elevation**

SCN2 Screen Type 2
Bifold glazing. PF2 finish.

SCN3 Screen Type 3
Aluminium plant screen.
PF3 finish.

SCN4 Screen Type 4 Aluminium plant screen. PF1 finish.

TURNER

02 11.12.20

01 01.12.20

Rev Date

For Information

As per plan, Medium colour

As per plan, Medium colour

As per plan, Medium colour

⇒ U = 6.7 and SHGC = 0.70

(All sliding/fixed/louvre windows/doors)

⇒ U = 6.7 and SHGC = 0.57

Weather stripping fitted on windows

Weather stripping fitted on windows

Weather stripping fitted on windows

Within apartments

NFRC Glazing System (Glass+Frame) values:

(All awning/casement windows/doors)

NFRC Glazing System (Glass+Frame) values:

(All sliding/fixed/louvre windows/doors) ⇒ U = 5.6 and SHGC = 0.36 (All awning/casement windows/doors)

NFRC Glazing System (Glass+Frame) values:

⇒ U = 5.4 and SHGC = 0.58

 \Rightarrow U = 5.4 and SHGC = 0.49

NFRC Glazing System (Glass+Frame) values: ⇒ U = 4.8 and SHGC = 0.59

(All sliding/fixed/louvre windows/doors)

(All awning/casement windows/doors)

NFRC Glazing System (Glass+Frame) values:

(All awning/casement windows/doors)

Medium colour

⇒ U = 4.3 and SHGC = 0.47

 \Rightarrow U = 4.3 and SHGC = 0.53

Weather stripping fitted on windows

All downlights comply with AS60598 IC-F Rating.

TURNER

02

Tile (Bathroom, laundry and Timber (Living and bedroom) To floor above unconditioned space

⇒ U = 4.8 and SHGC = 0.51

Weather stripping fitted on windows

⇒ U = 5.6 and SHGC = 0.41

Colour back glass + R2.0 Insulation + PE

Hebel+ R2.0 Insulation + PB

Hebel + Acoustic Insulation +PB

Single glazed, Clear Throughout, UNO

Aluminium frame,

Aluminium frame,

Aluminium frame, Double glazed, Clear

Aluminium frame,

Concrete floor

Downlights All LED downlights

Double glazed, High solar gain Low-E

Concrete floor with R2.0 floor insulation

Concrete + R3.5 Insulation + PB

Exhaust fans All exhaust fans to have draft stoppers attached.

Single glazed, low solar gain Low-E

Single glazed, High solar gain Low-E

To units 101,201,202,203,301,302,303,401,402,403,708,1007

To unit 406 (kitchen/living only),409 ,508(kitchen/living only),607(kitchen/living only) 706(kitchen/living only),1204 all windows/doors

To unit 410,509,608,707,805,806,905,906,1005,1006,1104,1203 (All sliding/fixed/louvre windows/doors windows/doors)

1:200, 1:100, 1:1.64 @A1, 50%@A3

For DA Submission

BF For Coordination

Approved by Revision Notes

20023

DA-210-003

DLCS Quality Endorsed Company ISO 9001:2015, Registration Number 20476 Nominated Architect: Nicholas Turner 6695, ABN 86 064 084 911

Materials Legend:

Louvre Type 2 Operable Glass Louvre Window with PF3 framing

Louvre Type 3 Fixed Horizontal Louvre System to plantrooms.

Pre-Adaptable 1:50

______ WINTERGARDEN

- Provide at least one double GPO at max. 300mm from front of work surface. - M denotes mirrored layout * Adaptable Units:
"Walls reinforcement to to be provided in accordance with AS4299" * Livable Units:
"Walls reinforcement to to be provided in accordance with Livable Housing Design Guidelines" A Capped off services on wall or floor for future WC relocation B Capped off services on wall or floor for future basin relocation

General Notes:

*Livable means silver level standard in Livable Housing Guideline's.

The GPO for the refrigerator shall be easily reachable when the refrigerator is in its operating position.

02 11.12.20 A 26.11.20 BF For DA Submission
BF For Coordination Rev Date Approved by Revision Notes 1:50 @A1, 50%@A3

Harbour Drive Coffs Harbour State Postcode Country Adaptable & Livable Apartment Layouts Sheet 01

- Accessible terrace to apartment 7.02 shown dotted

— Accessible terrace to apartment 7.02 shown dotted

SUMMARY

15-31 Harbour Drive

TYPE: 3 BED

CONFIG.: ADAPTABLE & LIVABLE

NO. OFF: 6

LOCATION: 7.02

8.02 9.02 10.02 11.02 12.02

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Paynter Dixon Level 2 2 Richardson Place Riverside Corporate Park North Ryde NSW 2113

DLCS Quality Endorsed Company ISO 9001:2015, Registration Number 20476 Nominated Architect: Nicholas Turner 6695, ABN 86 064 084 911

Pre-Adaptable 1:50

1000 Post-Adaptable 1:50

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"Walls reinforcement to to be provided in accordance with Livable Housing Design Guidelines" A Capped off services on wall or floor for future WC relocation B Capped off services on wall or floor for future basin relocation

General Notes:

SUMMARY TYPE: 3 BED
CONFIG.: ADAPTABLE & LIVABLE NO. OFF: 1 LOCATION: 12.01

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Harbour Drive Coffs Harbour State Postcode Country Adaptable & Livable Apartment Layouts Sheet 02

15-31 Harbour Drive

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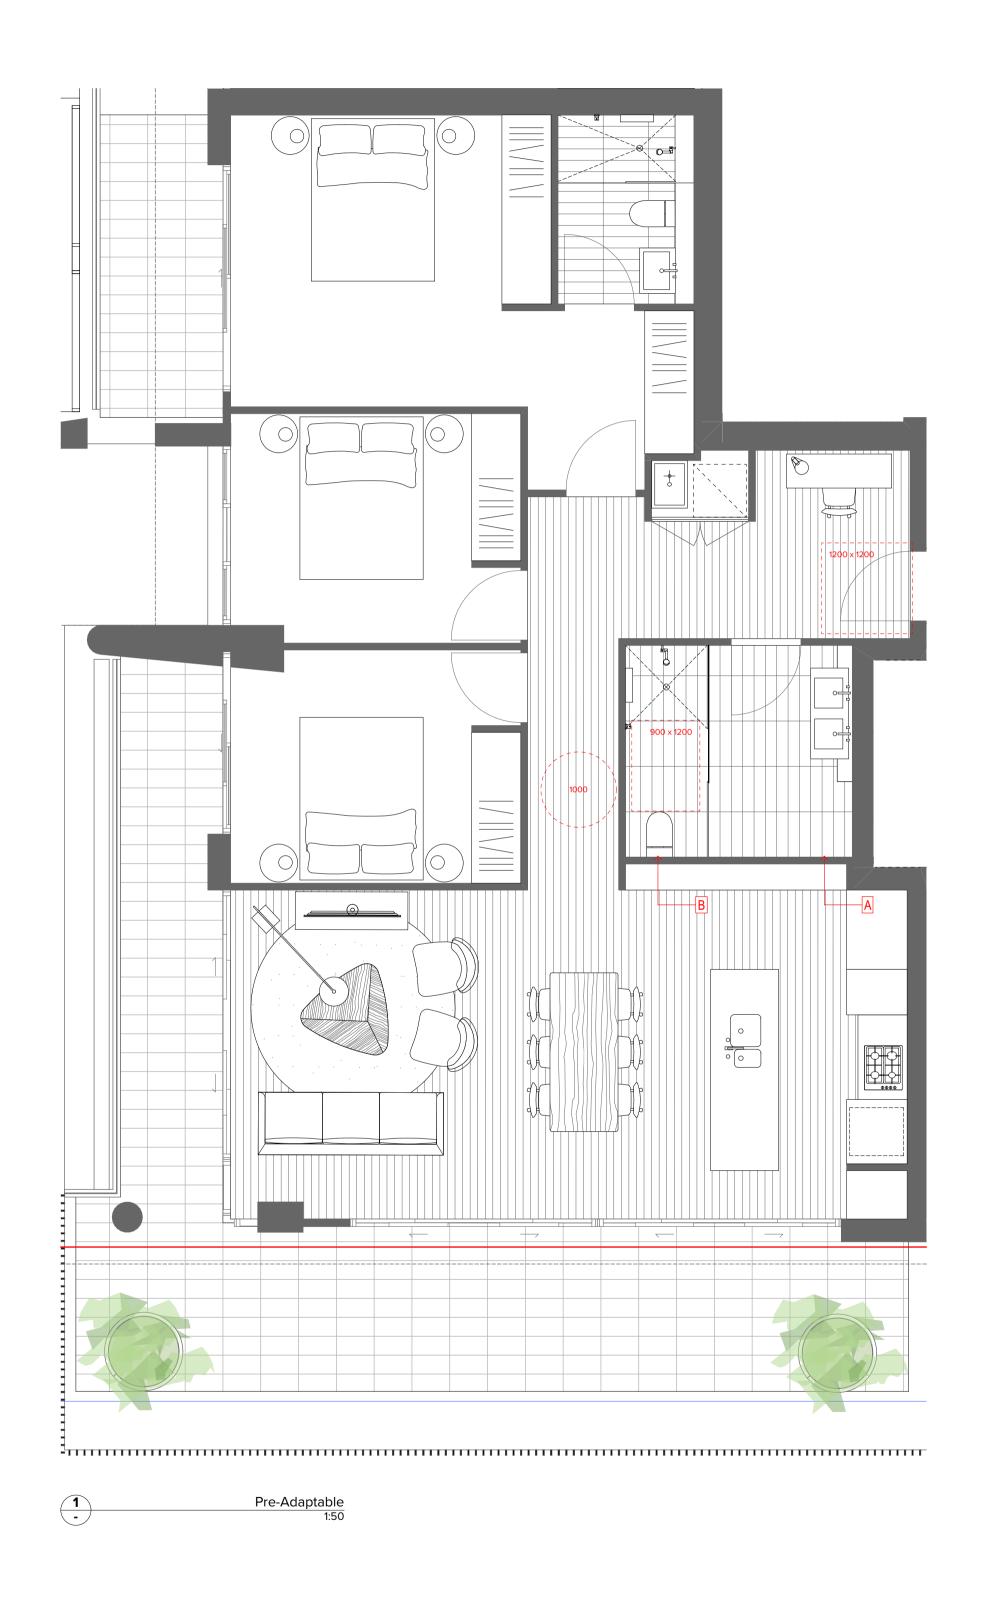
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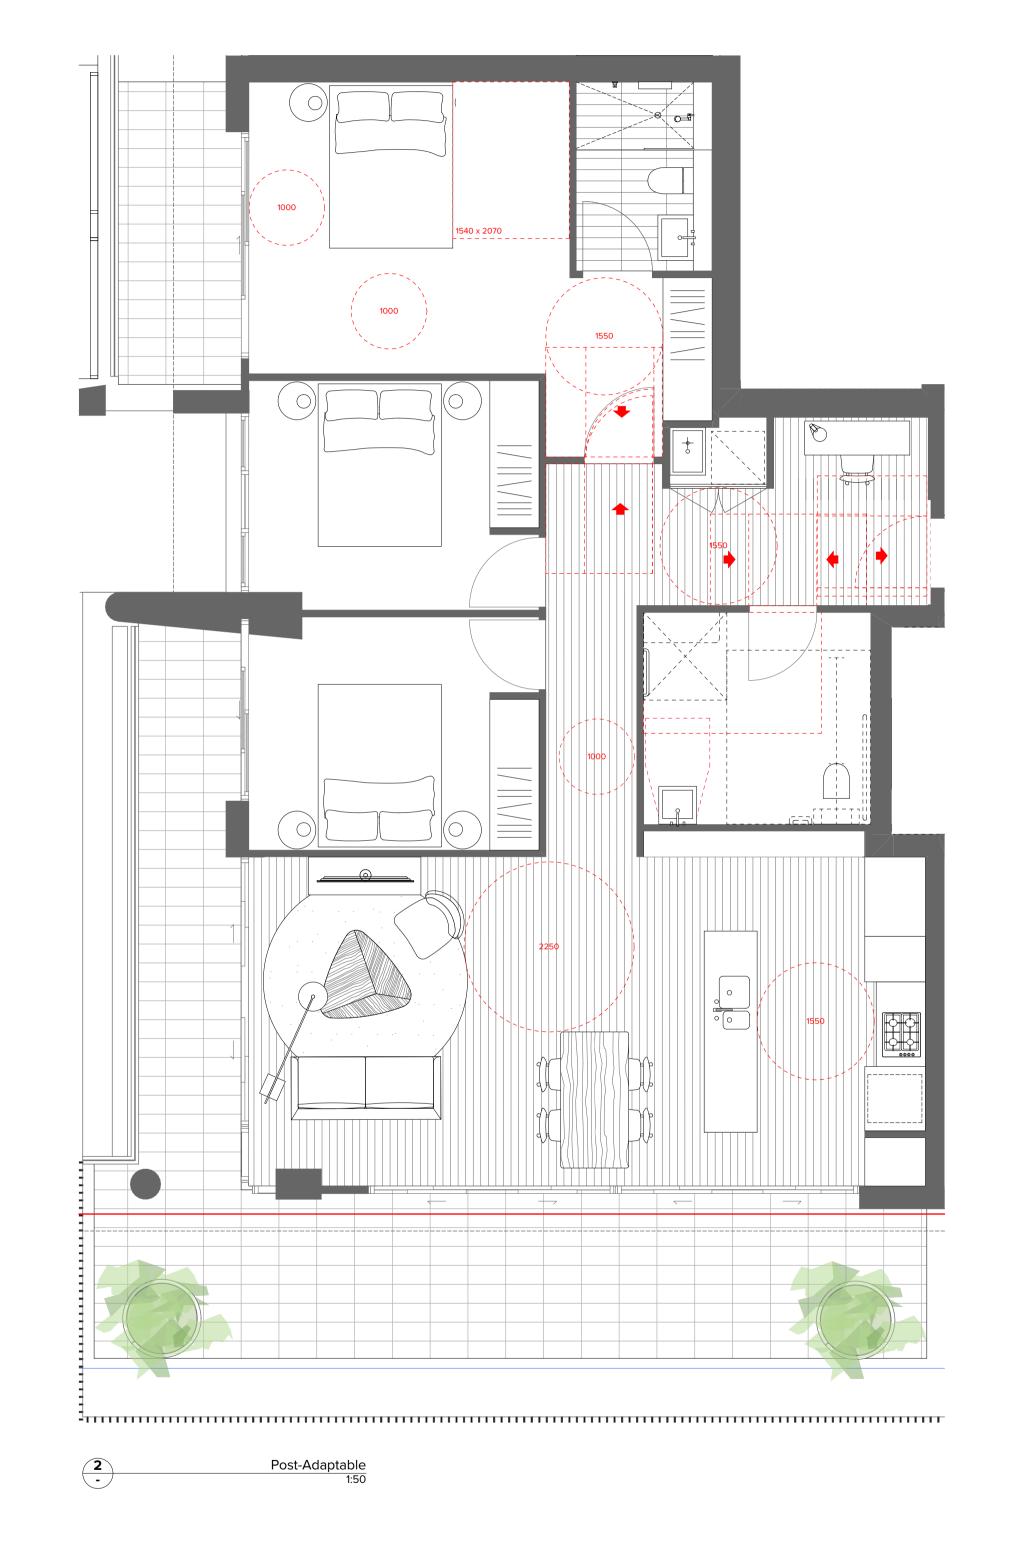
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DA-810-002

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SUMMARY TYPE: 3 BED
CONFIG.: ADAPTABLE & LIVABLE NO. OFF: 1

LOCATION: 12.04

02 11.12.20 01 26.11.20 For DA Submission

For Coordination 1:50 @A1, 50%@A3 DA-810-003

General Notes:

*Livable means silver level standard in Livable Housing Guideline's.

The GPO for the refrigerator shall be easily reachable when the refrigerator is in its operating position.

- Provide at least one double GPO at max. 300mm from front of work surface.

* Adaptable Units:
"Walls reinforcement to to be provided in accordance with AS4299"

* Livable Units:
"Walls reinforcement to to be provided in accordance with Livable Housing Design Guidelines"

A Capped off services on wall or floor for future WC relocation

B Capped off services on wall or floor for future basin relocation

- M denotes mirrored layout

Adaptable & Livable Apartment Layouts Sheet 03

Harbour Drive Coffs Harbour State Postcode Country

15-31 Harbour Drive

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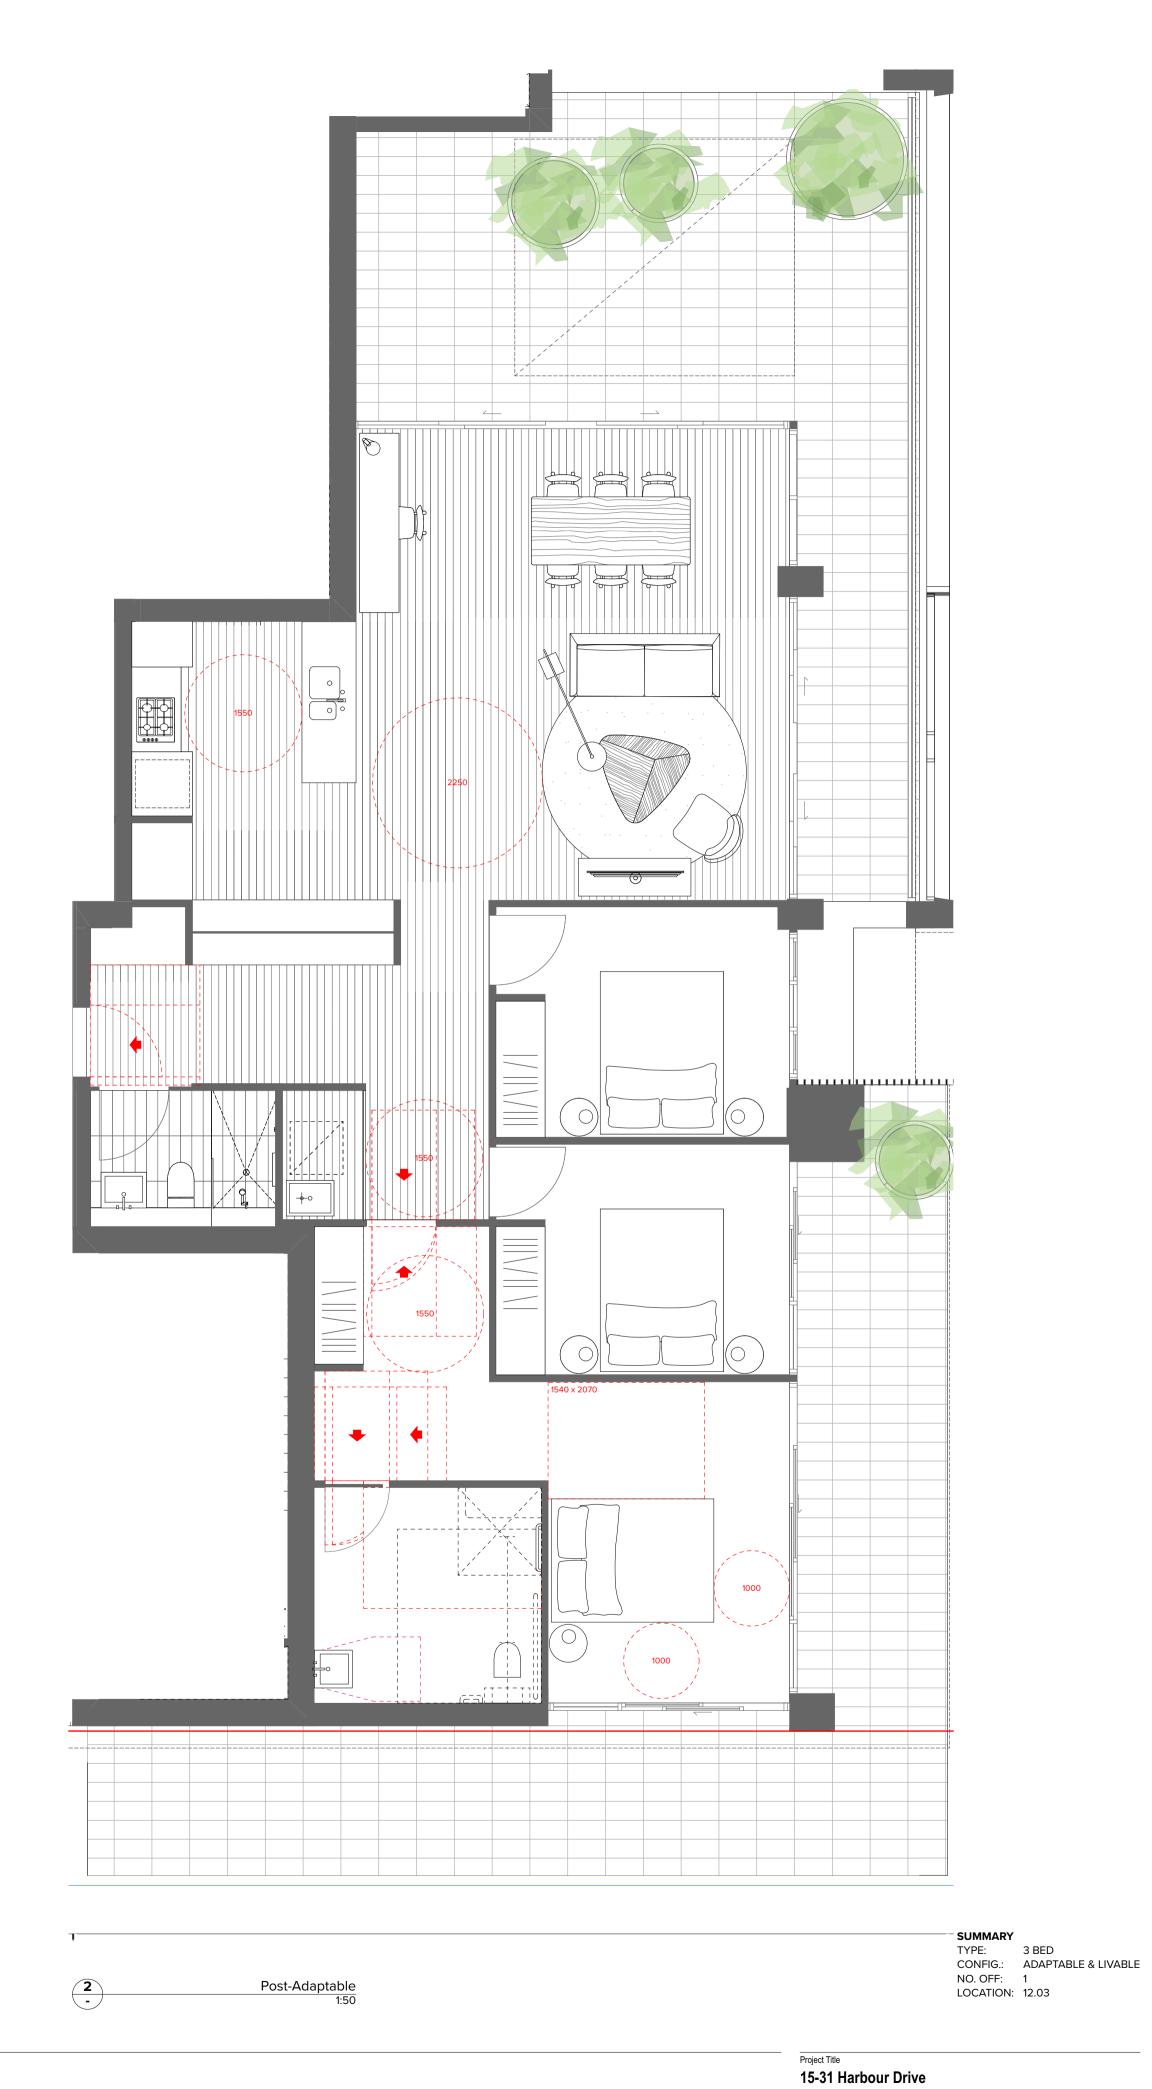
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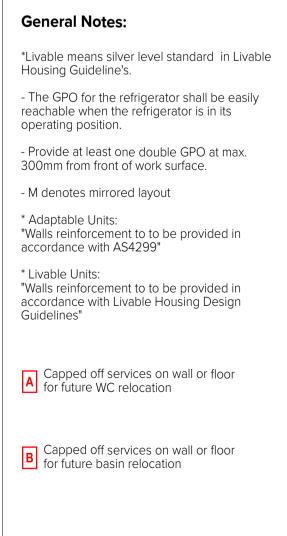
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Level 2 2 Richardson Place Riverside

Corporate Park North Ryde NSW 2113







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Harbour Drive Coffs Harbour State Postcode Country

Adaptable & Livable Apartment Layouts Sheet 04

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Post-Adaptable 1:50

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General Notes:

TYPE: 2 BED
CONFIG.: ADAPTABLE & LIVABLE NO. OFF: 1 LOCATION: 8.05

SUMMARY

15-31 Harbour Drive

Adaptable & Livable Apartment Layouts Sheet 05

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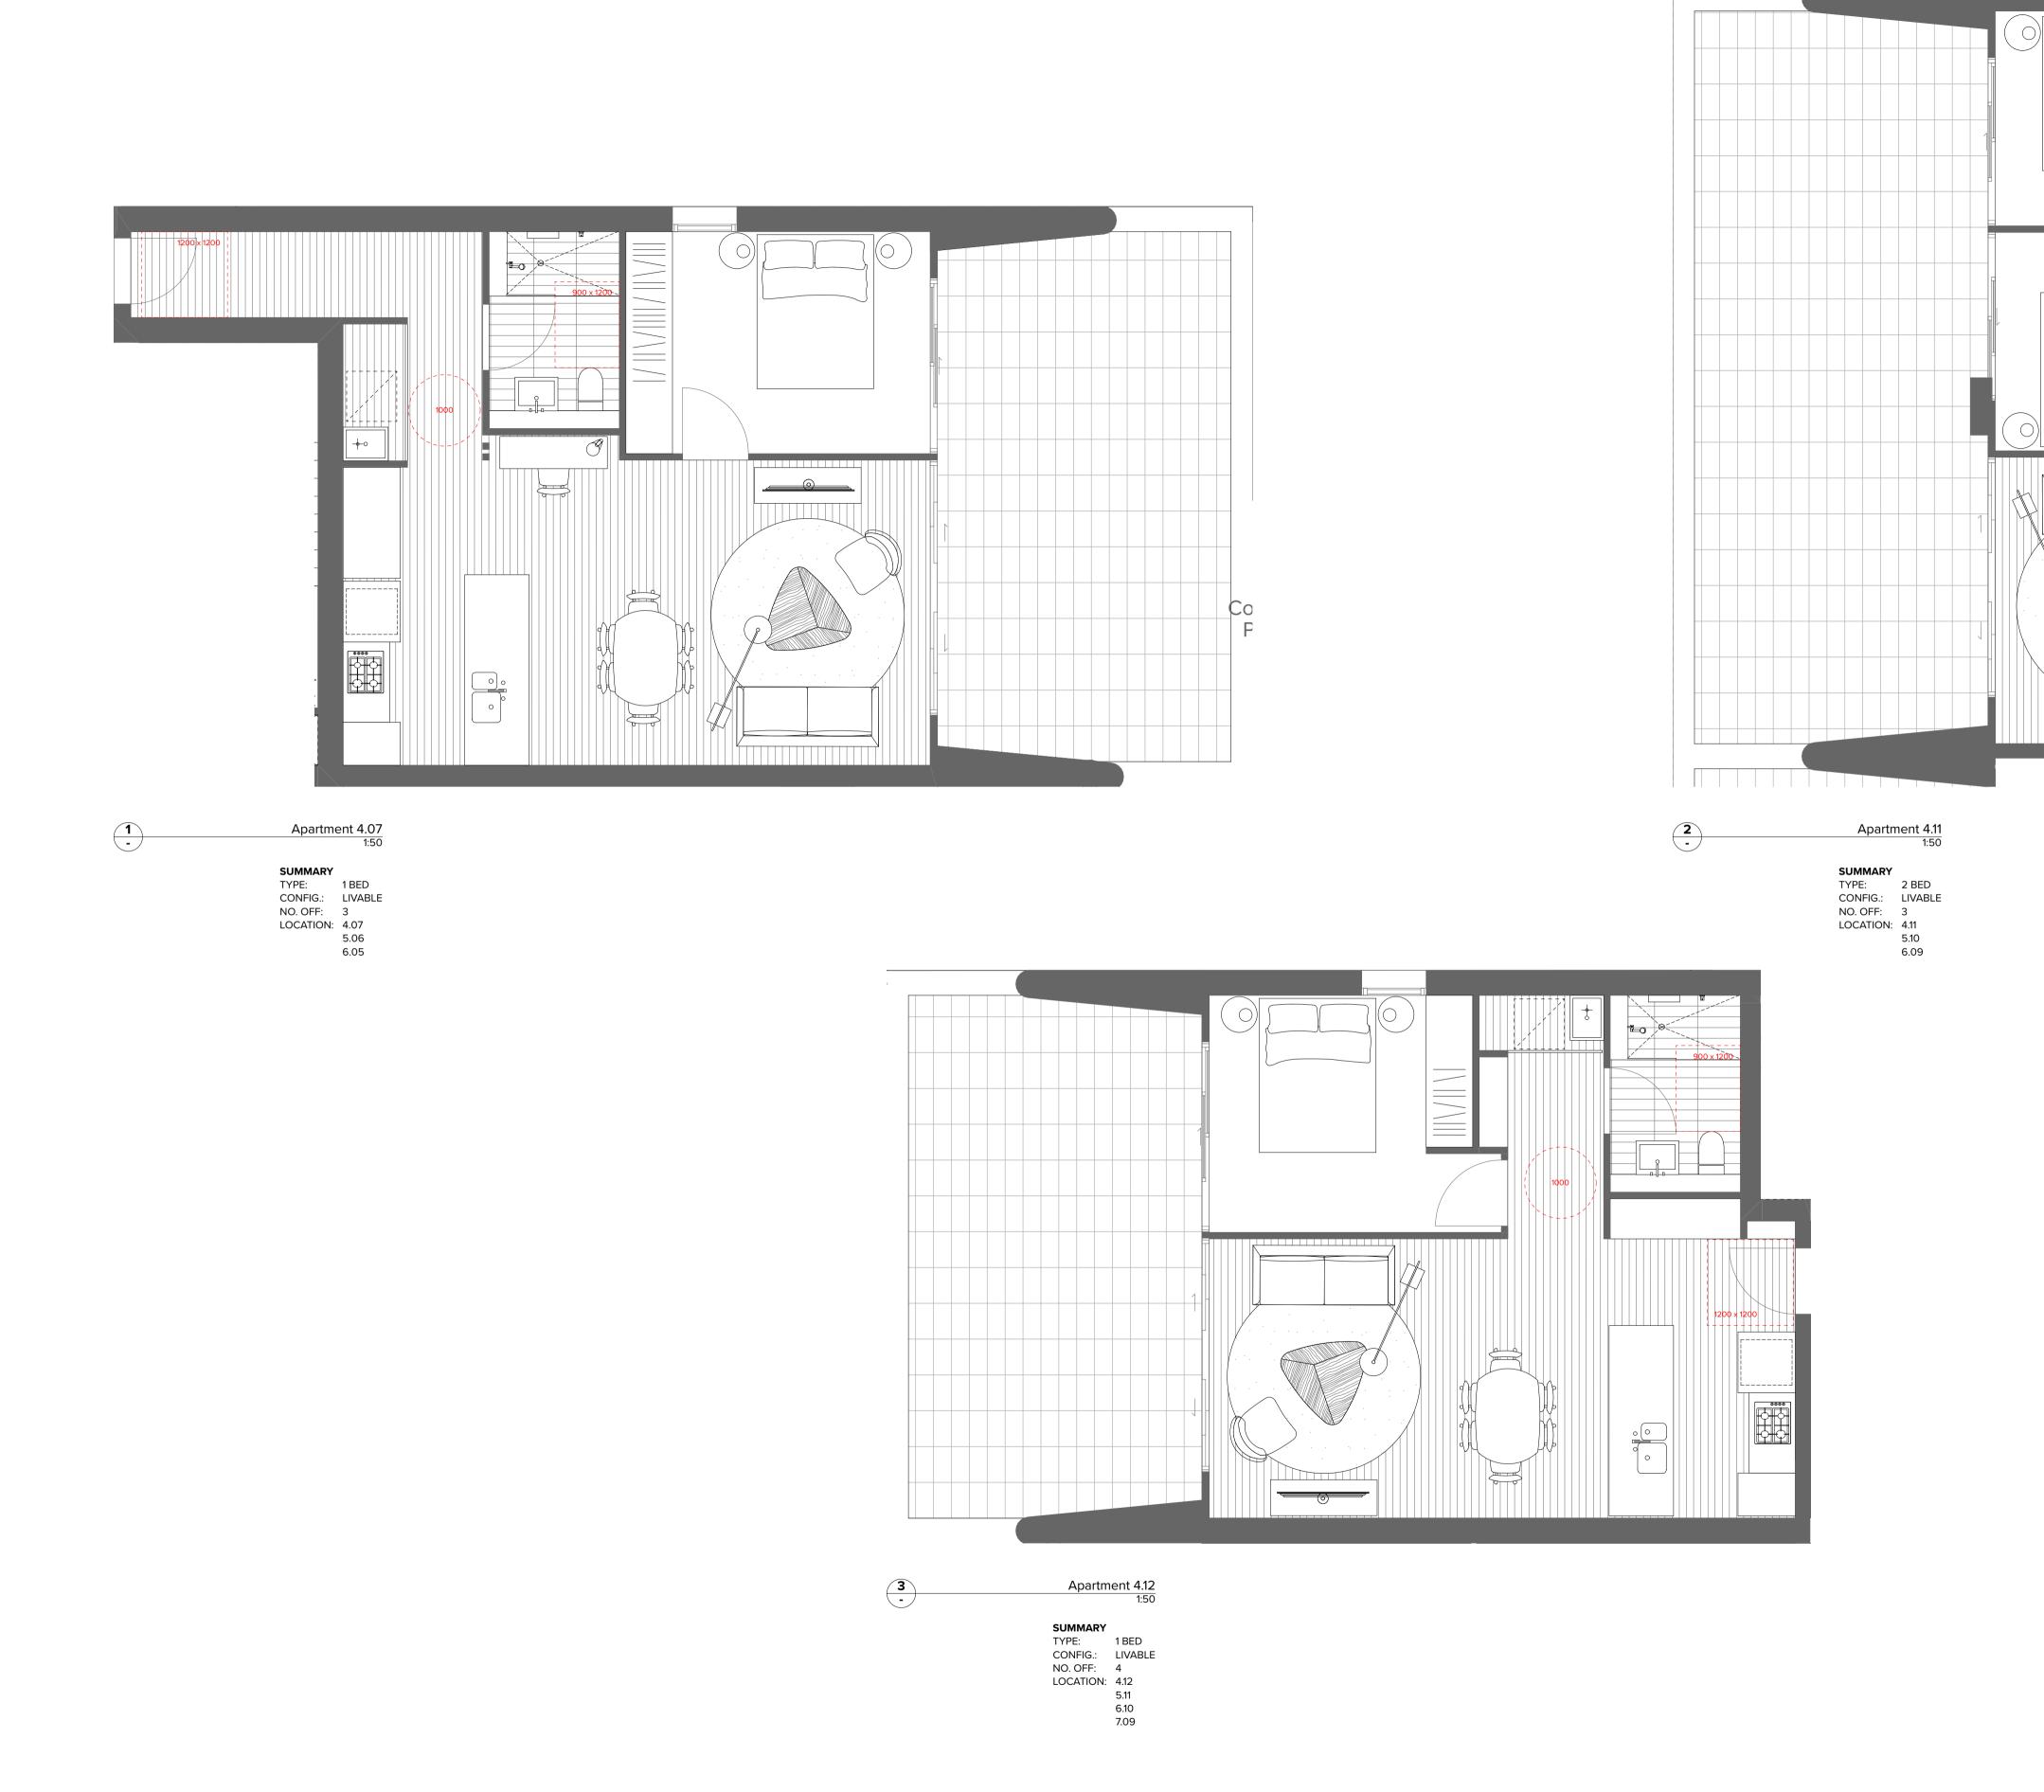
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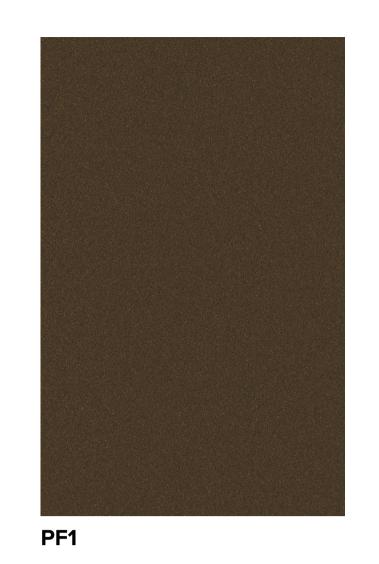
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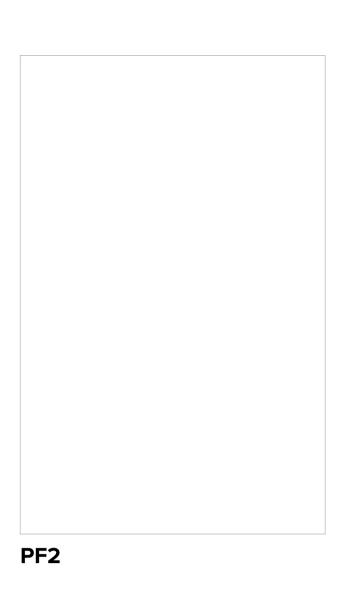
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Adaptable & Livable Apartment Layouts Sheet 06


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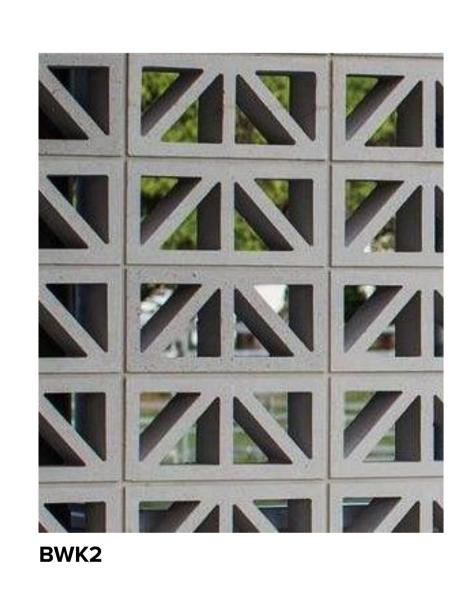












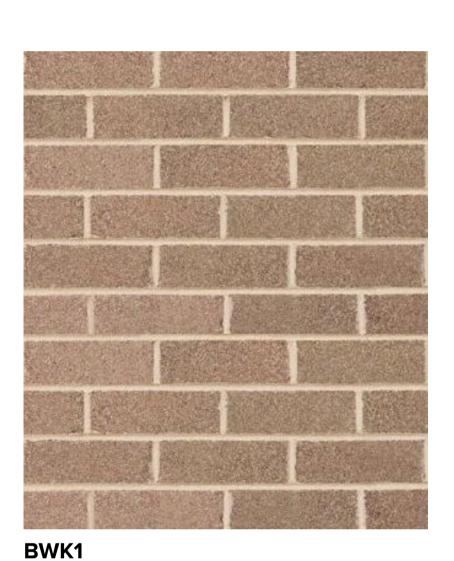

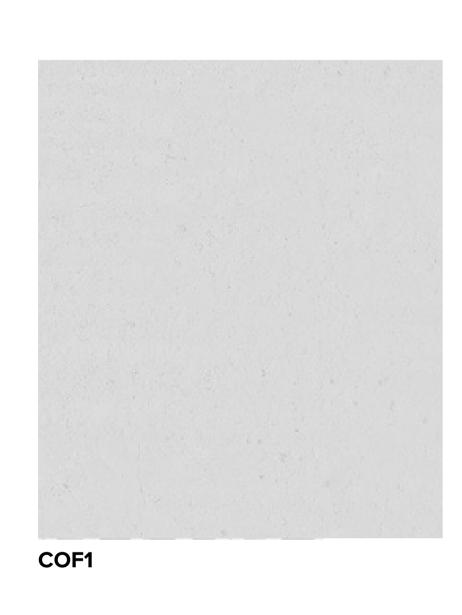





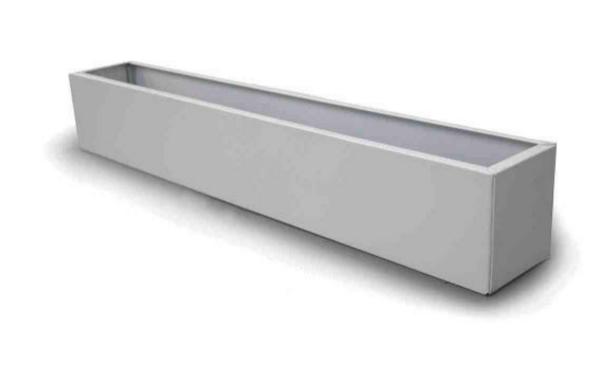

Materials Legend:

Balustrade Type 1
Vertical 100 x 20 metal baluster, no top rail.
Slab front fixed. Colour to match PF1.

Balustrade Type 2
Semi-Frameless opaque glass fixed to concrete upturn balustrade

Balustrade Type 3
Semi-frameless full height opaque glass.
PF3 Metal baluster fixed to slab

Balustrade Type 4
Horizontal balusters fixed to concrete upturn.
COF1 finish.

Brickwork Pattern Type 1
Stretcher Bond Austral Bowral Dry Pressed Brick
Colour to match "Simmental Silver"

BWK2 Brickwork Pattern Type 2
Perforated screening similar to Austral breeze-block

GC2 Residential Glazing with PF1 framing (Refer to BASIX for glass requirement)

Retail Glazing with PF3 framing (Refer to Section J for glass requirement)

GC3 Residential Glazing with PF2 framing (Refer to BASIX for glass requirement)

Residential Glazing with PF3 framing (Refer to BASIX for glass requirement)

GC5 Colourback Glazing with PF1 framing (Refer to BASIX for glass requirement)

GC6 Colourback Glazing with PF2 framing (Refer to BASIX for glass requirement)

Louvre Type 1
Operable Glass Louvre Window with PF1 framing

COF1
Concrete Off Form 1
Smooth off form concrete.
Penetrating clear matte sea Penetrating clear matte sealer over.

Louvre Type 2
Operable Glass Louvre Window with PF3 framing

Louvre Type 3 Fixed Horizontal Louvre System to plantrooms.

PF1 Paint Finish Type 1
Paint finish - light bronze or equivalent powdercoat finish where applicable

PF2 Paint Finish Type 2
Paint finish to match Dulux "Natural White" or equivalent powdercoat finish where applicable

(AW1) Awning with PF2 finish PF3 Paint Finish Type 3
Paint finish to match Dulux "Monument" or equivalent powdercoat finish where applicable

PLT1 Planter Type 1 GRC Planter

SCN1 Screen Type 1
Bifold glazing. PF1 finish.

PLT1

SCN2 Screen Type 2
Bifold glazing. PF2 finish.

SCN3 Screen Type 3
Aluminium plant screen.
PF3 finish.

SCN4 Screen Type 4 Aluminium plant screen. PF1 finish.

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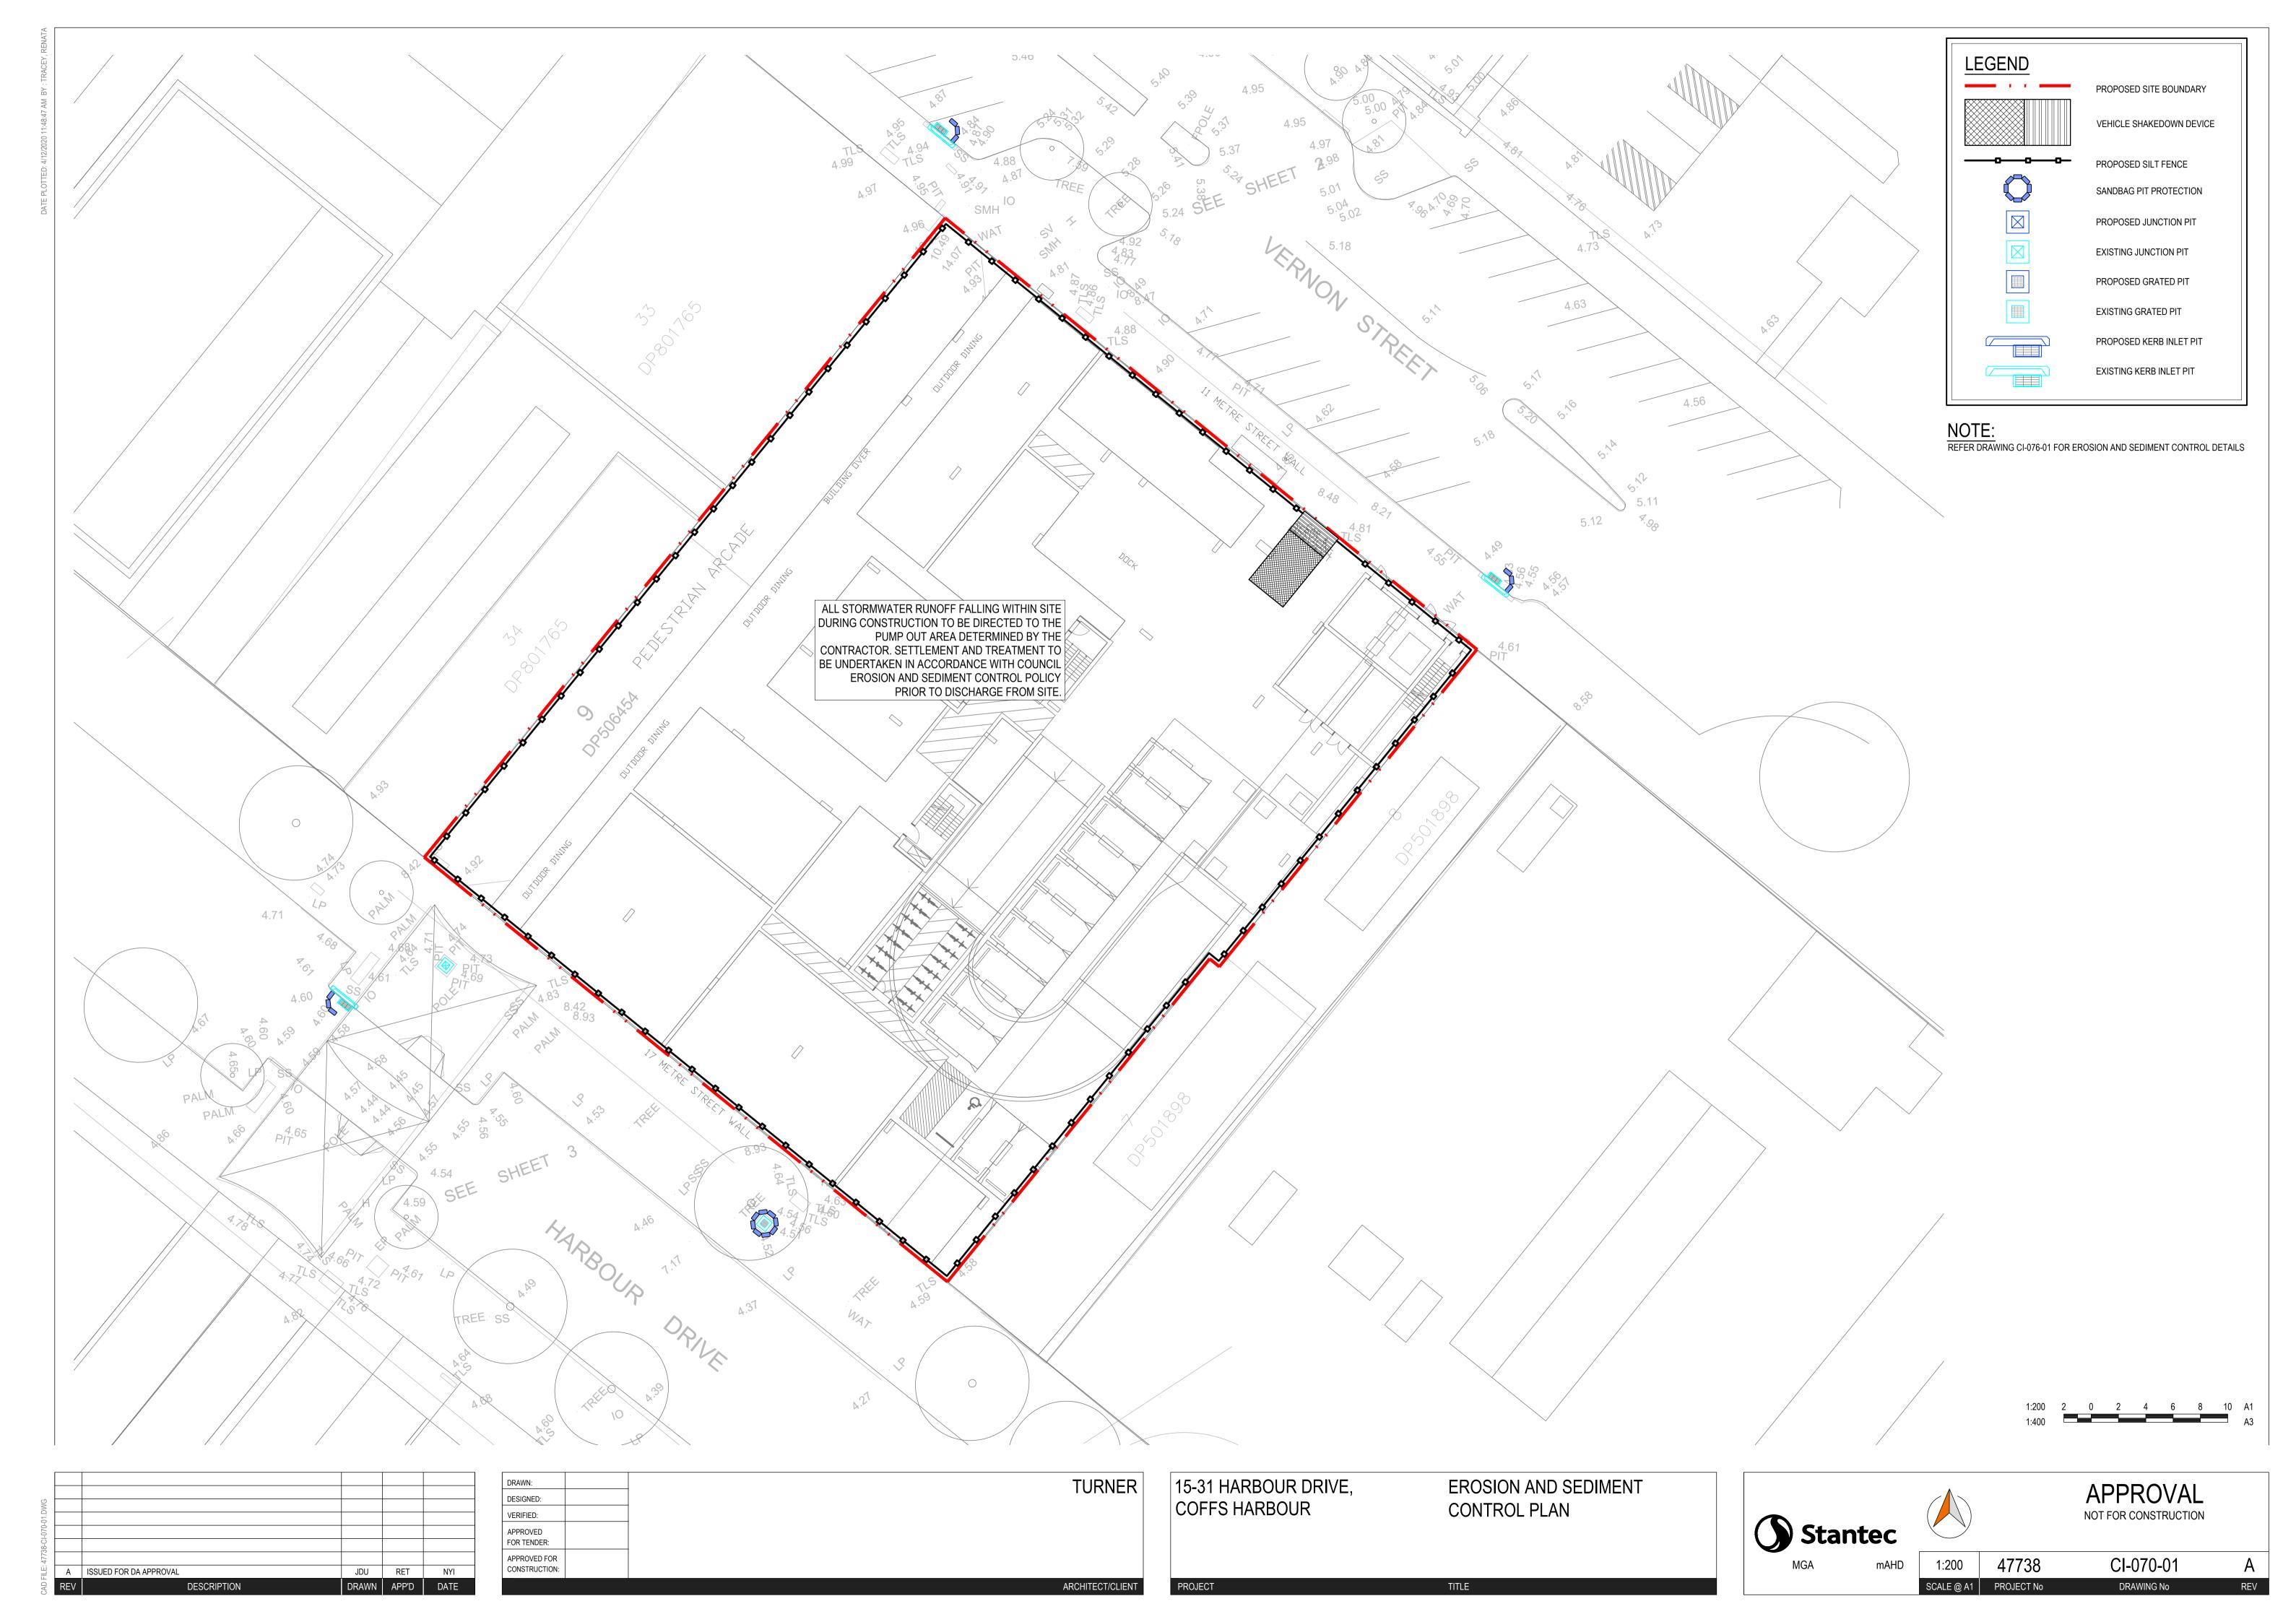
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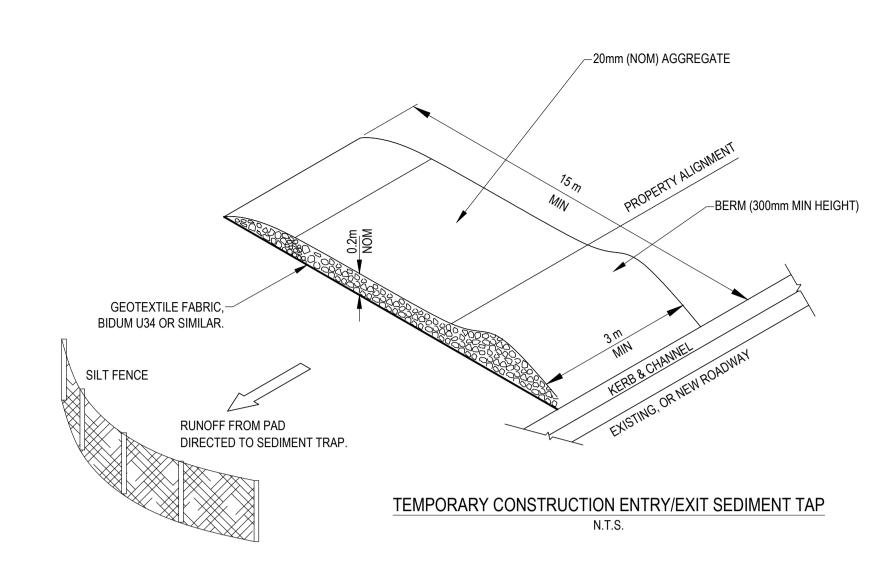
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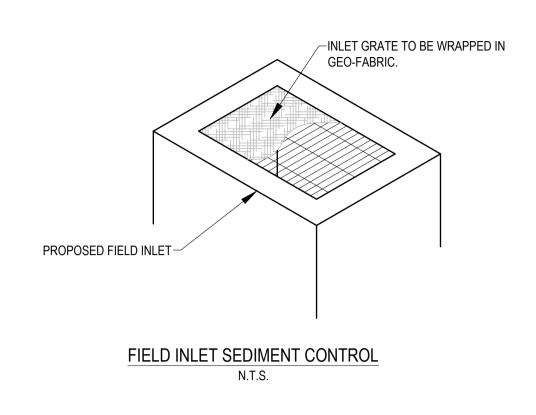
Materials & Finishes Board


External Materials Palette


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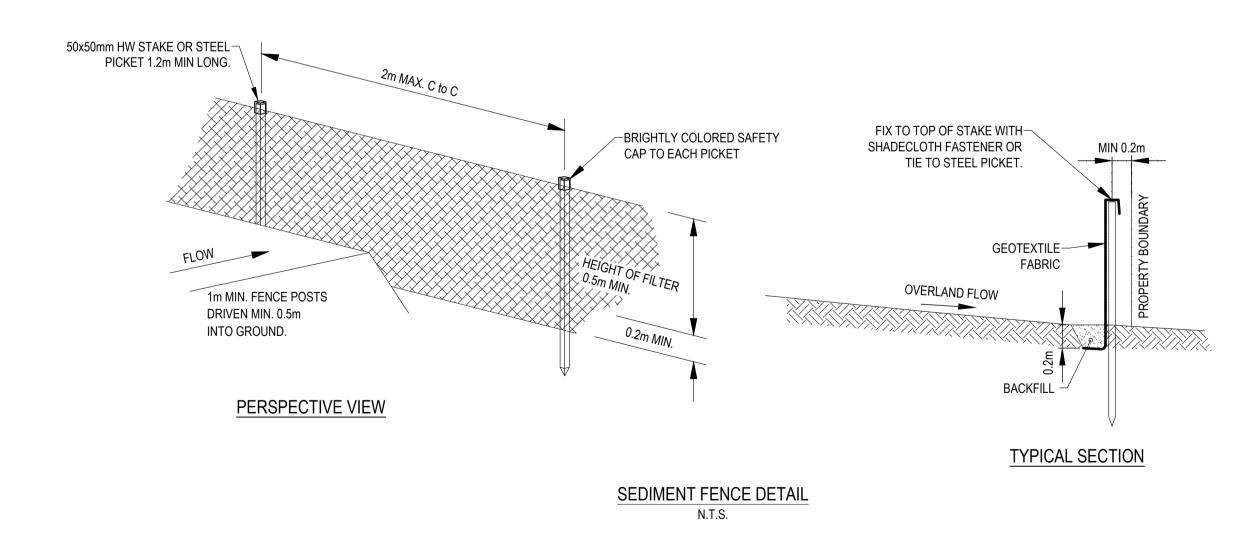









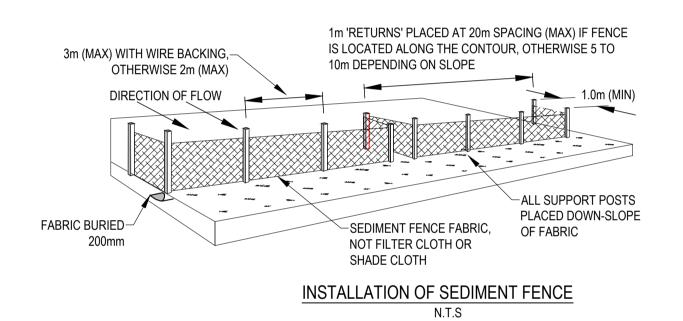

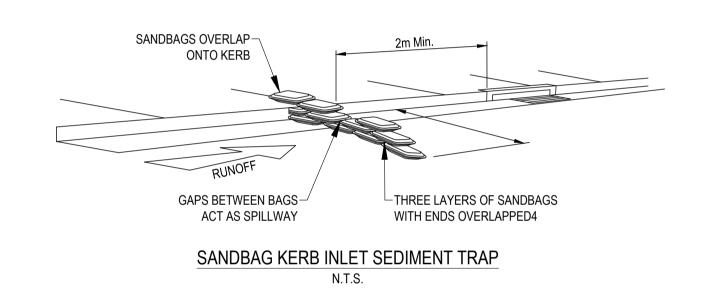

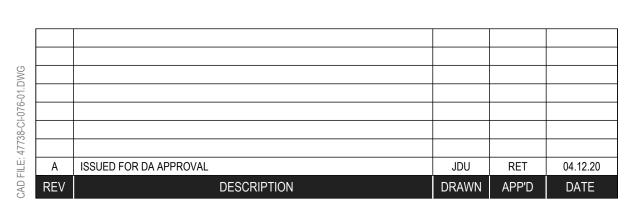

DRAWN:	TURNER
DESIGNED:	. •
VERIFIED:	
APPROVED FOR TENDER:	
APPROVED FOR CONSTRUCTION:	

15-31 HARBOUR DRIVE, COFFS HARBOUR	EROSION AND SEDIMENT CONTROL DETAILS
PROJECT	TITLE

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MGA	mAHD	NTS	47738	CI-076-01	Α
		SCALE @ A1	PROJECT No	DRAWING No	REV

1.01 GENERAL

The following general conditions should be considered prior to the commencement of landscape works:

- The landscape plans should be read in conjunction with the architectural plans, project arborist's assessment, hydraulic plans, service plans and survey prepared for the proposed development.
- All services including existing drainage should be accurately located prior to the commencement of landscape installation. Any proposed tree planting which falls close to services will be relocated on site under the
- instruction of the landscape architect Installation of conduit for required irrigation, electrical and other services shall be completed prior to the
- commencement of hardscape works and hardstand pours. All outdoor lighting specified by architect or client to be installed by qualified electrician
- Anomalies that occur in these plans should be brought to our immediate attention.
- Where an Australian Standard applies for any landscape material testing or installation technique, that standard shall be followed.

1.02 PROTECTION OF ADJACENT FINISHES

The Contractor shall take all precautions to prevent damage to all or any adjacent finishes by providing adequate protection to these areas / surfaces prior to the commencement of the Works

1.03 PROTECTION OF EXISTING TREES

Existing trees identified to be retained shall be done in accordance with (AS)4970-Protection of trees on development sites as well as in accordance with the tree protection measures prepared by project arborist.

Where general works are occurring around such trees, or pruning is required, a qualified Arborist shall be engaged to oversee such works and manage tree health. Existing trees designated on the drawing for retention shall be protected at all times during the construction period. Any soil within the drip-line of existing trees shall be excavated and removed by hand only. No stockpiling shall occur within the root zone of existing trees to be retained.

Any roots larger in diameter than 50mm shall only be severed under instruction by a qualified arborist. Roots smaller than 50mm diameter shall be cut cleanly with a saw.

Temporary fencing shall be installed around the base of all trees to be retained prior to the commencement of landscape works. Where possible this fencing will be located around the drip line of these trees, or a minimum of 3m from the trunk. The fencing shall be maintained for the full construction period.

1.04 EROSION & POLLUTION CONTROL

The Contractor shall take all proper precautions to prevent the erosion of soil from the subject site. The contractor shall install erosion & sediment control barriers and as required by council, and maintain these barriers throughout the construction period. Note that the sediment control measures adopted should reflect the soil type and erosion characteristics of the site.

Erosion & pollution control measures shall incorporate the following:

- Construction of a sediment trap at the vehicle access point to the subject site. - Sediment fencing using a geotextile filter fabric in the location indicated on the erosion control plan or as instructed on

site by the landscape architect. - Earth banks to prevent scour of stockpiles

- Sandbag kerb sediment traps - Straw bale & geotextile sediment filter

- Exposed banks shall be pegged with an approved Jute matting in preparation for mass planting Refer to "Sitewise Reference Kit" as prepared by DLWC & WSROC (1997) for construction techniques

SOIL WORKS

2.01 MATERIALS

Specified Soil Conditioner (Generally to improve site soil)

The specified soil conditioner for site top-soil improvement shall be an organic mix, equal to "Botany Humus", as supplied by ANL. Note that for sites where soil testing indicates toxins or extremes in pH, or soils that are extremely poor, allow to excavate and supply 300mm of imported soil mix.

New gardens & proposed Planting

New garden and planting areas shall consist of a 50/50 mix of clean site soil (refer d) below) and imported "Organic Garden Mix" as supplied by ANL or approved equal. All mixes are to comply with AS 4419 Soils for landscaping & garden use, & AS 4454 Composts, Soil conditioners & mulches.

Specified Soil Mix - Turf The specified soil mix for all turf areas shall be a min 75mm layer of imported soil mix consisting of 80% washed river

sand (reasonably coarse), and 20% composted organic matter equivalent to mushroom compost or soil conditioner, or other approved lawn top dress.

Site topsoil is to be clean and free of unwanted matter such as gravel, clay lumps, grass, weeds, tree roots, sticks, rubbish and plastics, and any deleterious materials and materials toxic to plants. The topsoil must have a pH of between 5.5 and 7. Use 100% imported soil mix when site when site topsoil runs out.

2.02 INSTALLATION (TO GARDEN OUTSIDE OF TREE PROTECTION ZONES OF TREES RECOMMENDED TO BY

Note: No level changes (Cut or Fill), soil ripping within the Tree Protection Zones of trees to be retained

All testing is to be conducted in accordance with AS 1289 Methods for testing soils for engineering purposes. Site soil

shall be given a pH test prior to modifying to ensure conditions are appropriate for planting as stated above. Tests shall

Note that a soil test conducted by the "Sydney Soil Lab" or approved equal shall be prepared for all commercial. industrial and multi-unit residential sites. The successful landscape contractor shall implement the recommendations of

b) Set Out of Individual Trees & Mass Planting Areas

All individual tree planting positions and areas designated for mass planting shall be set out with stakes or another form of marking, ready for inspection and approval. Locate all services.

c) Establishing Subgrade Levels outside of tree protection zones of trees to be retained Subgrade levels are defined as the finished base levels prior to the placement of the specified material (i.e. soil

conditioner). The following subgrade levels shall apply: Mass Planting Beds - 300mm below existing levels with specified imported soil mix

Turf areas - 100mm below finished surface level. Note that all subgrades shall consist of a relatively free draining natural material, consisting of site topsoil placed

previously by the Civil Contractor. No builders waste material shall be acceptable. d) Subgrade Cultivation

Cultivate all subgrades to a minimum depth of 100mm in all planting beds and all turf areas, ensuring a thorough breakup of the subgrade into a reasonably coarse tilth. Grade subgrades to provide falls to surface and subsurface drains, prior to

e) Drainage Works

Install surface and subsurface drainage where required and as detailed on the drawing. Drain subsurface drains to outlets provided, with a minimum fall of 1:100 to outlets and / or service pits.

f) Placement and Preparation of Specified Soil Conditioner & Mixes.

Trees in turf & beds - Holes shall be twice as wide as root ball and minimum 100mm deeper - backfill hole with 50/50 mix of clean site soil and imported "Organic Garden Mix" as supplied by ANL or approved equal. Mass Planting Beds - Install specified soil conditioner to a compacted depth of 100mm

Place the specified soil conditioner to the required compacted depth and use a rotary hoe to thoroughly mix the conditioner into the top 300mm of garden bed soil. Ensure thorough mixing and the preparation of a reasonably fine tilth and good growing medium in preparation for planting.

 Turf Areas - Install specified soil mix to a minimum compacted depth of 75mm. Place the specified soil mix to the required compacted depth and grade to required finished soil levels, in preparation for

planting and turfing. PLANTING

3.01 MATERIALS

a) Quality and Size of Plant Material

All trees supplied above a 25L container size must be grown and planted in accordance with AS 2303:2018 'TREE STOCK FOR LANDSCAPE USE' Certification that trees have been grown to AS 2303:2018 is to be provided upon request of Council's Tree Management Officer.

Above - Ground Assessment: The following plant quality assessment criteria should be followed:

Plant true to type, Good vigour and health, free from pest & disease, free from injury, self-supporting, good stem taper, has been pruned correctly, is apically dominant, has even crown symmetry, free from included bark & stem junctions, even trunk position in pot, good stem structure

Below - Ground Assessment: Good root division & direction, rootball occupancy, rootball depth, height of crown, non-suckering For further explanation and description of these assessment criteria, refer to Ross Clark's book.

All Plant material shall be to the type and size specified. No substitutions of plant material shall be permitted without written prior approval by the Landscape Architect. No plant shall be accepted which does not conform to the standards

b) Stakes and Ties

Provide min, 3 No. Stakes and ties to all plants identified as trees in the plant schedule. Stakes shall be sound, unpainted, straight hardwood, free of knots and pointed at one end. They shall be 1800mm x 50mm x 50mm Hardwood timber, or as per council specification where is available. Ties shall be 50mm wide hessian webbing material.

Fertilisers shall be approved slow release fertilisers suitable for the proposed planting types. Note that for native plants. specifically Proteaceae family plants including Grevillea species, low phosphorus fertilizers shall be used.

Mulch for general planter bed shall be an approved equal to "Forest Blend" as supplied by ANL. Mulch shall be completely free from any soil, weeds, rubbish or other debris. Mulch for bio-retention/rain garden area where is required shall be non-floatable materials that could include crushed rock, gravel, coarse river sand, scoria or river pebbles. 4-7mm screenings or similar.

Turf for project site shall be soft leaf Buffalo or Zoysia macrantha 'Nana' or equivalent unless stated otherwise), free from any weeds and other grasses, and be in a healthy growing condition. Re-turfing to nature strip where is required shall use species that match existing on street.

3.02 INSTALLATION

a) Setting Out All planting set out shall be in strict accordance with the drawings, or as directed. Note that proposed tree planting located near services should be adjusted at this stage. Notify Landscape Architect for inspection for approval prior to

b) Planting

All plant material shall be planted as soon after delivery as possible. Planting holes for trees shall be excavated as detailed and specified. Plant containers shall be removed and discarded, and the outer roots gently teased from the soil mass. Immediately set plant in hole and backfill with specified soil mix, incorporating the approved quantity of fertiliser for each plant type. Ensure that plants are set plumb vertically and root balls set to the consolidated finished grades detailed on the drawings. Compact the backfilled soil and saturate by hand watering to expel any remaining air pockets immediately after planting.

c) Staking and Tying Staking and tying shall be in strict accordance with the drawings and shall occur immediately following plant placement and soil backfilling. All plants identified as "Trees" on the planting schedule shall be staked with a min. 3 stakes.

Mulch for general planter bed shall be an approved equal to "Forest Blend" as supplied by ANL. Mulch shall be completely free from any soil, weeds, rubbish or other debris. Mulch for bio-retention/rain garden area where is required shall be non-floatable materials that could include crushed rock, gravel, scoria or river pebbles. 4-7mm screenings or

Moisten soil prior to the turf being laid. Turf shall be neatly butt jointed and true to grade to finish flush with adjacent surfaces. Incorporate a lawn fertilizer and thoroughly water in. Keep turf moist until roots have taken and sods/rolls cannot be lifted. Keep all traffic off turf until this has occurred. Allow for top dressing of all turf areas. All turf shall be rolled immediately following installation

Where is required, the Contractor shall install xxxxxxx as detailed on the drawings, to all mass planting beds adjoining turf or gravel mulched areas, and where required. The resultant edge shall be true to line and flush with adjacent surfaces. However, no edging shall be used within the Structural Root Zone (SRZ) of trees to be retained.

All walls which form part of drainage works must be built as detailed by the hydraulic engineer. All walls exceeding 800mm shall be of not timber construction materials, construction details to be provided by a qualified engineer. Install wall to suit site levels and to manufacture's specification.

4.01 GENERAL

The Contractor shall undertake the installation of all hardscape works as detailed on the drawing, or where not detailed by manufacturers specification.

Paving - refer to typical details provided, and applicable Australian Standards. Permeable paving may be used as a suitable means of satisfying Council permeable surface requirements, while providing a useable, hardwearing, practical surface. In most instances, the client shall nominate the appropriate paving material to

Australian Standards shall be adhered to in relation to all concrete, masonry & metal work. Some details are typical and may vary on site. All hardscape works shall be setout as per the drawings, and inspected and approved by the Landscape Architect prior to installation. All workmanship shall be of the highest standard. Any queries or problems that arise from hardscape variations should be bought to the attention of the Landscape Architect. Your attention is directed to any obligations or responsibilities under the Dividing Fences Act, 1991 in respect of adjoining

property owner/s which may arise from this application. Any enquiries in this regard may be made to the Crown Lands Division on (02) 8836 5332

IRRIGATION WORKS

5.01 GENERAL (PERFORMANCE SPECIFICATION)

New irrigation systems to planting areas shall be a Commercial Grade Irrigation System conforming to all relevant Australian standards, including AS 3500 & the Electrical Safety Act 2002, Workplace Health & Safety Act 2011, & the

An automated drip-irrigation system is to be installed to all gardens, planters and lawn areas in accordance with the approved Irrigation Design.

This system shall be designed and installed by a qualified and licensed irrigation specialist, to the highest industry standards and to maximise the efficient usage of water. The Installer is required to obtain all approvals necessary for the completion of works in accordance with the Laws of

Australia, Laws of the State of NSW, Coffs Harbour Council By-Laws and Ordinances.

The Landscape Contractor nominated Licensed Irrigation Specialist shall provide irrigation drawings for approval upon

Design Requirements

engagement.

- The irrigation system shall be installed prior to all planting works. It shall incorporate a commercially available irrigation system, with sub-surface dripper lines to irrigate all gardens, planters and lawn areas.

- It shall incorporate a suitable back flow prevention device for the scale of works, an in-line filter, check valves, and suitable high and low density poly hose fittings and PVC piping to achieve flow rates suitable for specified planting. - The irrigation application rate shall not exceed the infiltration rate of the soil or creates run-off. - The landscape contractor shall check the existing pressure available from the ring mains and size irrigation piping to

suit. Supply shall be from local hose cock where available. - All piping and fittings shall be buried 50mm below the finished soil levels in garden and lawn areas, and secured in position at 500mm centres with galv wire pins. - Size of pipes shall be selected to ensure the working pressure at the end of the line does not decrease by more than

Services Co-ordination: - Co-ordination required by Landscape Contractor or Project Manager to provide required conduit, pipe work and penetration through slabs and planter walls for water and power provisions. - The Landscape Contractor shall be engaged with the Irrigation Specialist to co-ordinate with the Project Manager to

identify the preferred service and conduit locations. - Project Manager and Landscape Contractor to establish area suitable for irrigation control system with required area, power provision and water supply.

Testing & Defects:

Upon completion of installation, the system shall be tested, including:

- Main Line Pressure Test: The main line is pressurised to test for leaks. All valves are shut and the pressure is taken over a determined length of time. - Dripper Pressure Test: Measurement at flushing valves are taken and the pressure gauged to make sure it conforms to the manufacturer recommendations. The inlet pressure is then tested under the same conditions to check it does not

- All components are to be satisfactorily functional and operational prior to approval. Should any defect develop, or the capacity or efficiency of the system decline during the agreed maintenance system, then these faults shall be immediately rectified.

- A full 12 month warranty shall be included to cover labour and all parts.

- On request, a detailed irrigation performance specification report can be issued. CONSOLIDATION AND MAINTENANCE

6.01 GENERAL

Further Documentation:

The consolidation and maintenance period shall be either: 6 months beginning from the approved completion of the specified construction work (Practical Completion) as agreed to in the landscape contractors contractual obligations.

or as specified by Council in the Determination. A qualified landscape maintenance contractor shall undertake the required landscape maintenance works. Consolidation and maintenance shall mean the care and maintenance of Contracted works by accepted landscaping or horticultural practices, ensuring that all plants are in optimum growing conditions and appearance at all times, as well as rectifying

This shall include, but not be limited to, the following items where and as required:

 Watering all planting and lawn areas / irrigation maintenance. Clearing litter and other debris from landscaped areas. Removing weeds, pruning and general plant maintenance

any defects that become apparent in the contracted works.

Replacement of damaged, stolen or unhealthy plants.

• Make good areas of soil subsidence or erosion. Topping up of mulched areas.

 Spray / treatment for Insect and disease control. Fertilizing with approved fertilizers at correct rates.

• Mowing lawns & trimming edges each 14 days in summer or 18 days in winter Adjusting ties to Stakes Maintenance of all paving, retaining and hardscape elements.

On the completion of the maintenance period, the landscape works shall be inspected and at the satisfaction of the superintendent or landscape architect, the responsibility will be signed over to the client.

VERNON STREET



REV DATE **COFFS HARBOUR** PAYNTER DIXON

NOTATION/AMENDMENT A 17.12.2020 For submission COFFS HARBOUR

PROPOSED PUBLIC DOMAIN & MIXED-USE DEVELOPMENT 15-31 HARBOUR DRIVE,

DEVELOPMENT APPLICATION TITLE PAGE December 2020 E.W RF Α TITLE PAGE

STREET VIEWS

SITE CONTEXT



HARBOUR DRIVE

PROJECT SITE

SHEET#	DRAWING TITLE	REV
/1 /2 /3 /4 /5 /6 /7	TITLE PAGE LANDSCAPE PLAN - PUBLIC DOMAIN (GF) HARDSCAPE PLAN- PUBLIC DOMAIN (GF) LANDSCAPE PLAN - LEVEL 1, 2 & 3 LANDSCAPE PLAN - LEVEL 4 DETAILS 1 DETAILS 2 -PERGOLA DETAILS 3- FURNITURE	A A A A A

DRAWING SCHEDULE

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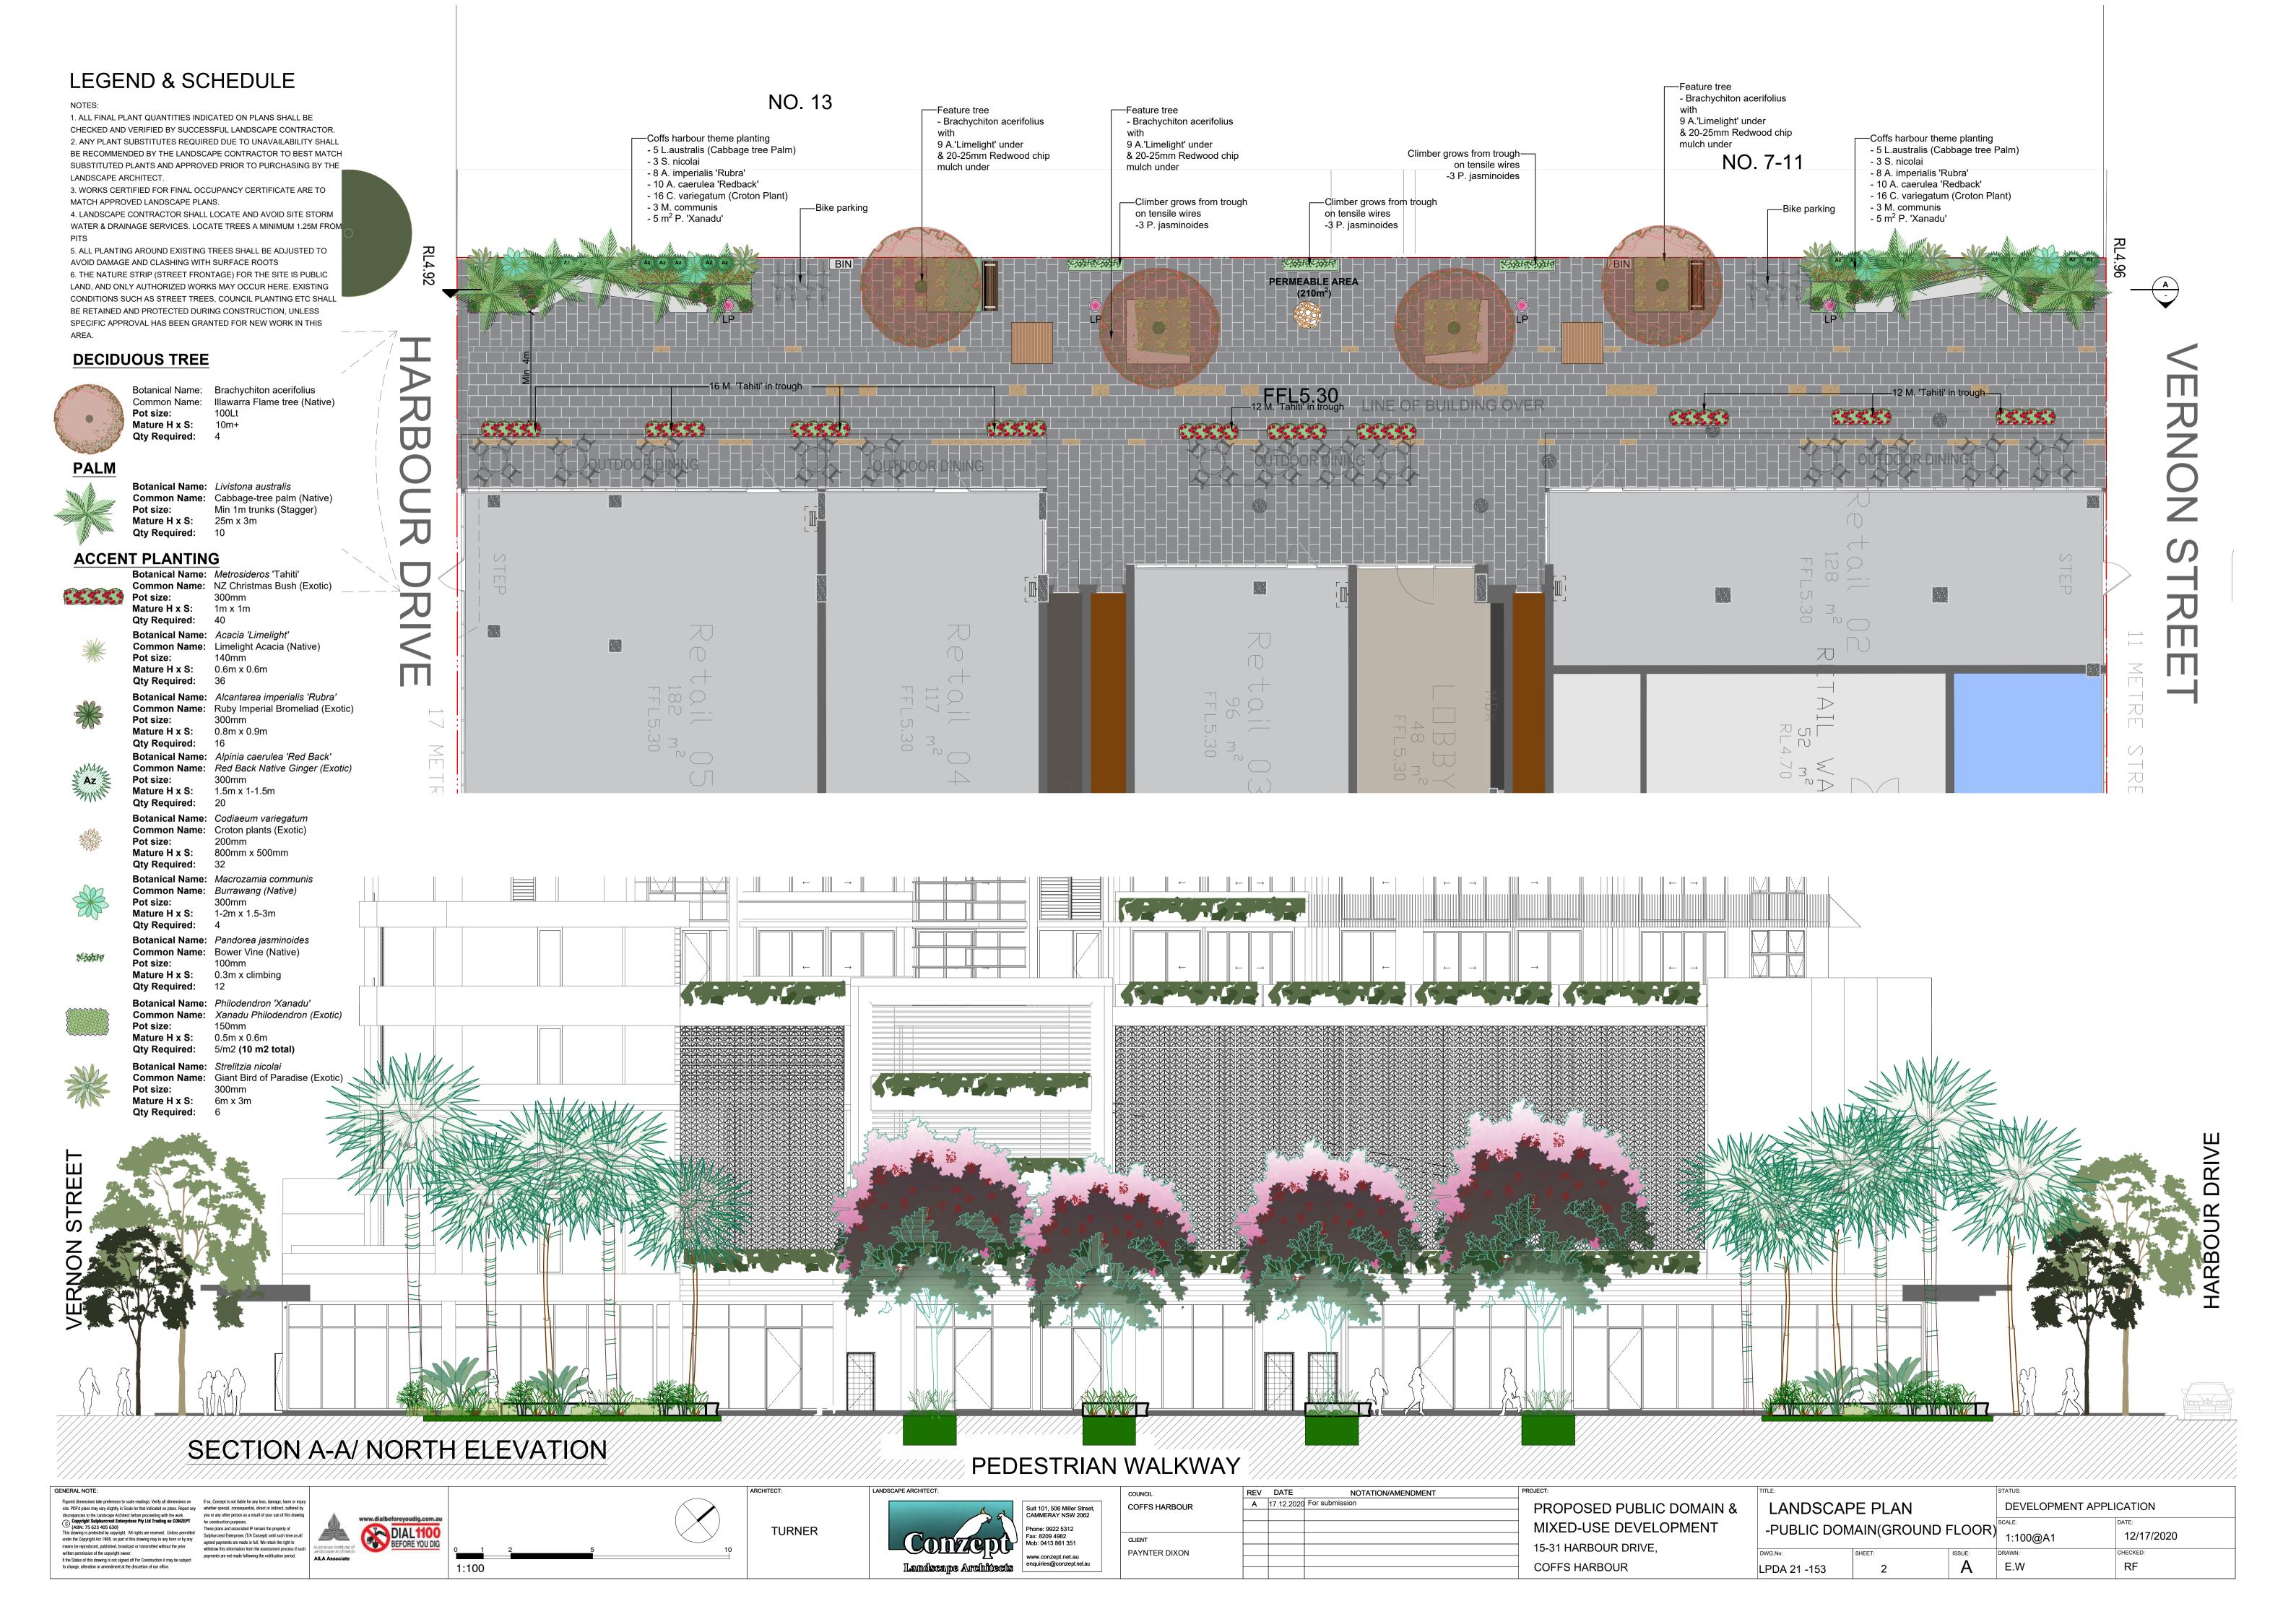
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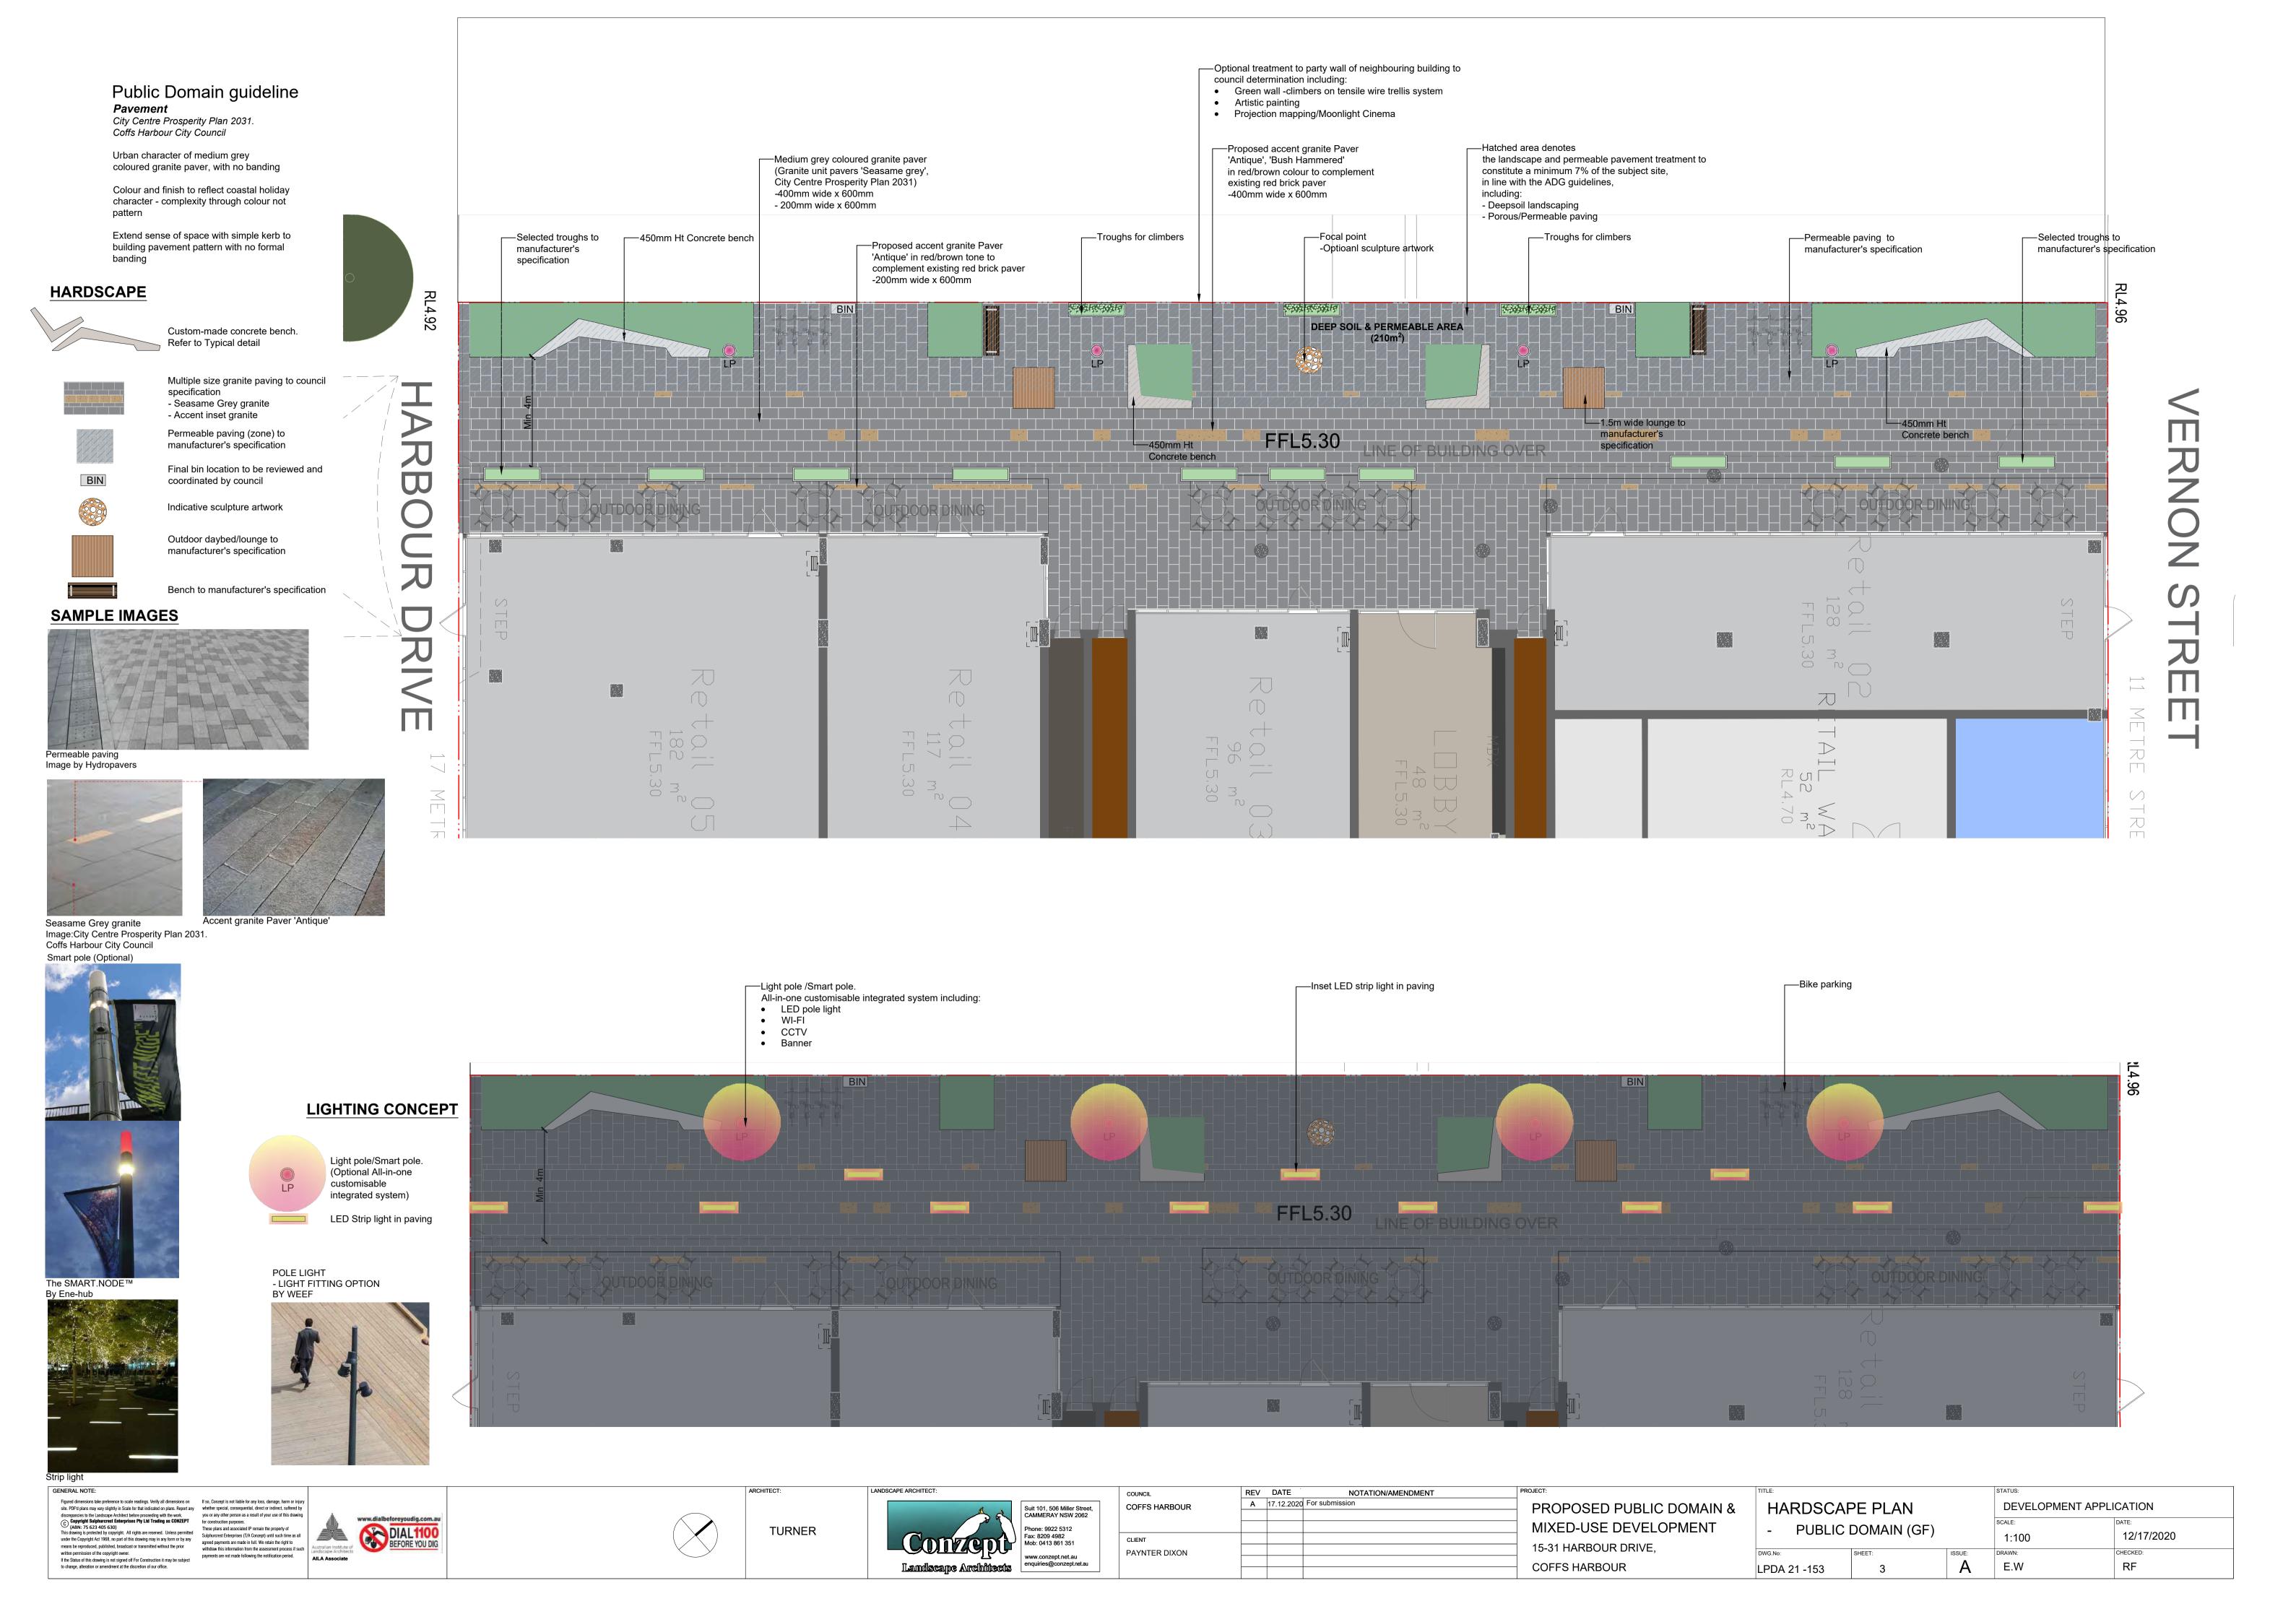
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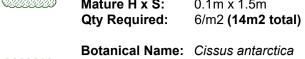




ACCENT PLANTING

Pot size: **Mature H x S:** 0.1m x 1.5m

Botanical Name: Casuarina glauca 'Cousin It' Common Name: Cousin It Casuarina (Native)




Botanical Name: Cissus antarctica Common Name: Kangaroo Vine (Native) Pot size:

Mature H x S: 0.3m x spreading



Qty Required: 6/m2 (35m2 total) Botanical Name: Dichondra argentea 'Silver Falls' Common Name: Silver Fall Dichondra (Exotic) Pot size: 140mm Mature H x S: 0.15m x spreading

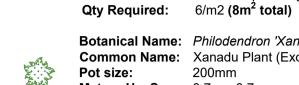

Botanical Name: Philodendron 'Xanadu' Common Name: Xanadu Plant (Exotic) Pot size: **Mature H x S:** 0.7m x 0.7m



Botanical Name: Russelia equisetiformis Common Name: Firecracker (Exotic) Pot size:

Mature H x S: 1m x 1.2m Qty Required: 43 **SAMPLE IMAGES**

Qty Required: 7

Prefabricated planter to be integrated on building facade to










Casuarina 'Cousin It'



Cissus antarctica

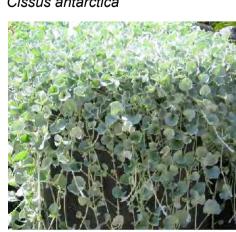

Dichondra argentea 'Silver Falls'

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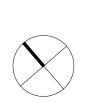
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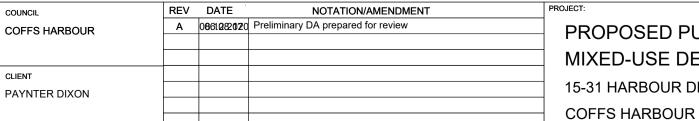
LEVEL 1 PLANTER



- 8m² D. 'Silver Falls'

TURNER






PROPOSED PUBLIC DOMAIN & MIXED-USE DEVELOPMENT 15-31 HARBOUR DRIVE,

DEVELOPMENT APPLICATION LANDSCAPE PLAN - LEVEL 1, 2 & 3 12/17/2020 1:100 Α E.W RF LPDA 21 -153



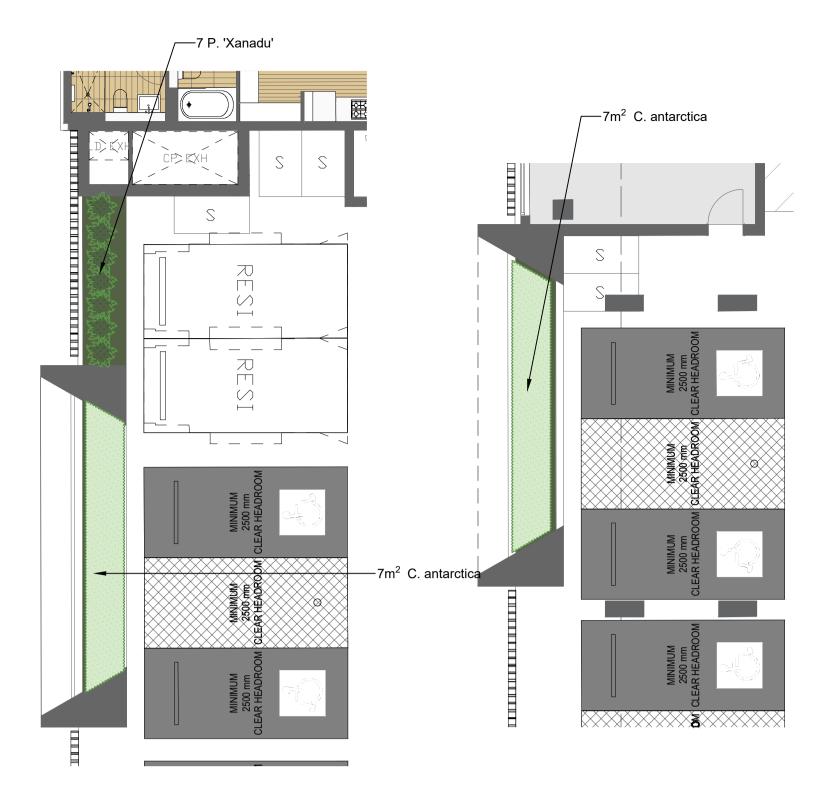

Communal Open Space Rooftop Terraces GENERAL NOTE

LEVEL 2 PLANTER

BCA & Australian Standards (AS):

N.T.S

Building codes and standards are established on a federal level by the nationally recognised Building Code of Australia (BCA), & these apply to all phases of construction, including balustrade design and specification. Specifically, BCA 2012 Parts 3.9.1 (stairs) and 3.9.2 (balustrades) and Australian Standard 1170.1 cover regulations for balustrades on stairways, balconies, rooftop terraces and other surfaces between levels

LEVEL 3 PLANTER

BCA Balustrade Regulations and Standards

A balustrade is defined as a rail and its balusters (posts or other supporting members). BCA regulations state that a balustrade must:

- Be at least 1 metre high as measured from the finished floor;
- Have openings between risers or posts no greater than 125mm; and
- Be able to withstand loads and impacts as determined by AS 1170.1

The height regulation of 1 metre ensures the balustrade is high enough to provide prevention against falling over the balustrade. The openings between risers or posts cannot be greater than 125mm to prevent children from falling between them. Load and impact regulations are designed to ensure balustrades can resist impact or will not collapse when pressure is applied to them from any direction.

Balustrade Safety & Planters

BCA regulations state that the balustrade must be 1 metre or more, higher than the finished floor. On roof-top terraces, planters & furniture are often incorporated in the landscape design. It's important for compliance and safety that these elements do not undermine the safety of Communal Open Space (COS) terraces and rooftops, and the compliance with the BCA and AS's are maintained.

Items to consider are:

- Where planters form the safety balustrade, their internal face must be 1m non-climbable
- Outdoor furniture such as tables, BBQs, and seating shall be fixed and located a minimum 1m away
- Where furniture is proposed to be fixed or adjacent to COS terrace planters which form the balustrade, then a compliant handrail will be required to be fixed to the external edge of the planter


A concern for COS areas on rooftops or terrace areas is that the strata will add loose furniture which ultimately could undermine the safety of the installed balustrades. In this case, it shall be the strata bodies responsibility to manage the safety of these areas.

Ultimately, the compliance and safety of the COS areas shall be the responsibility of the builder, and carefully inspected and certified at the Occupation Certificate (OC) stage of the development

Maintenance of COS area

Communal Open Space terrace and rooftop areas are exposed to extremes (wind, sun, and extreme weather) so maintenance is important. The following item should be included or considered:

- **All planters shall be structurally water-proofed**, with this work certified and periodically inspected. Trades should be closely monitored so they do not subsequently damage completed waterproofing
- All planters shall be irrigated with an automated system set on an approved watering pattern. Moisture gauges should be installed in some planters to minimize overwatering
- Tree Anchors shall be installed in high wind areas to larger plants, such as palms & small trees
- Compliance for balustrades and handrails should be monitored regularly
- For the maintenance of large rooftop areas and planters without external balustrades, **anchoring points** for tying off harnesses for landscape maintenance workers are essential

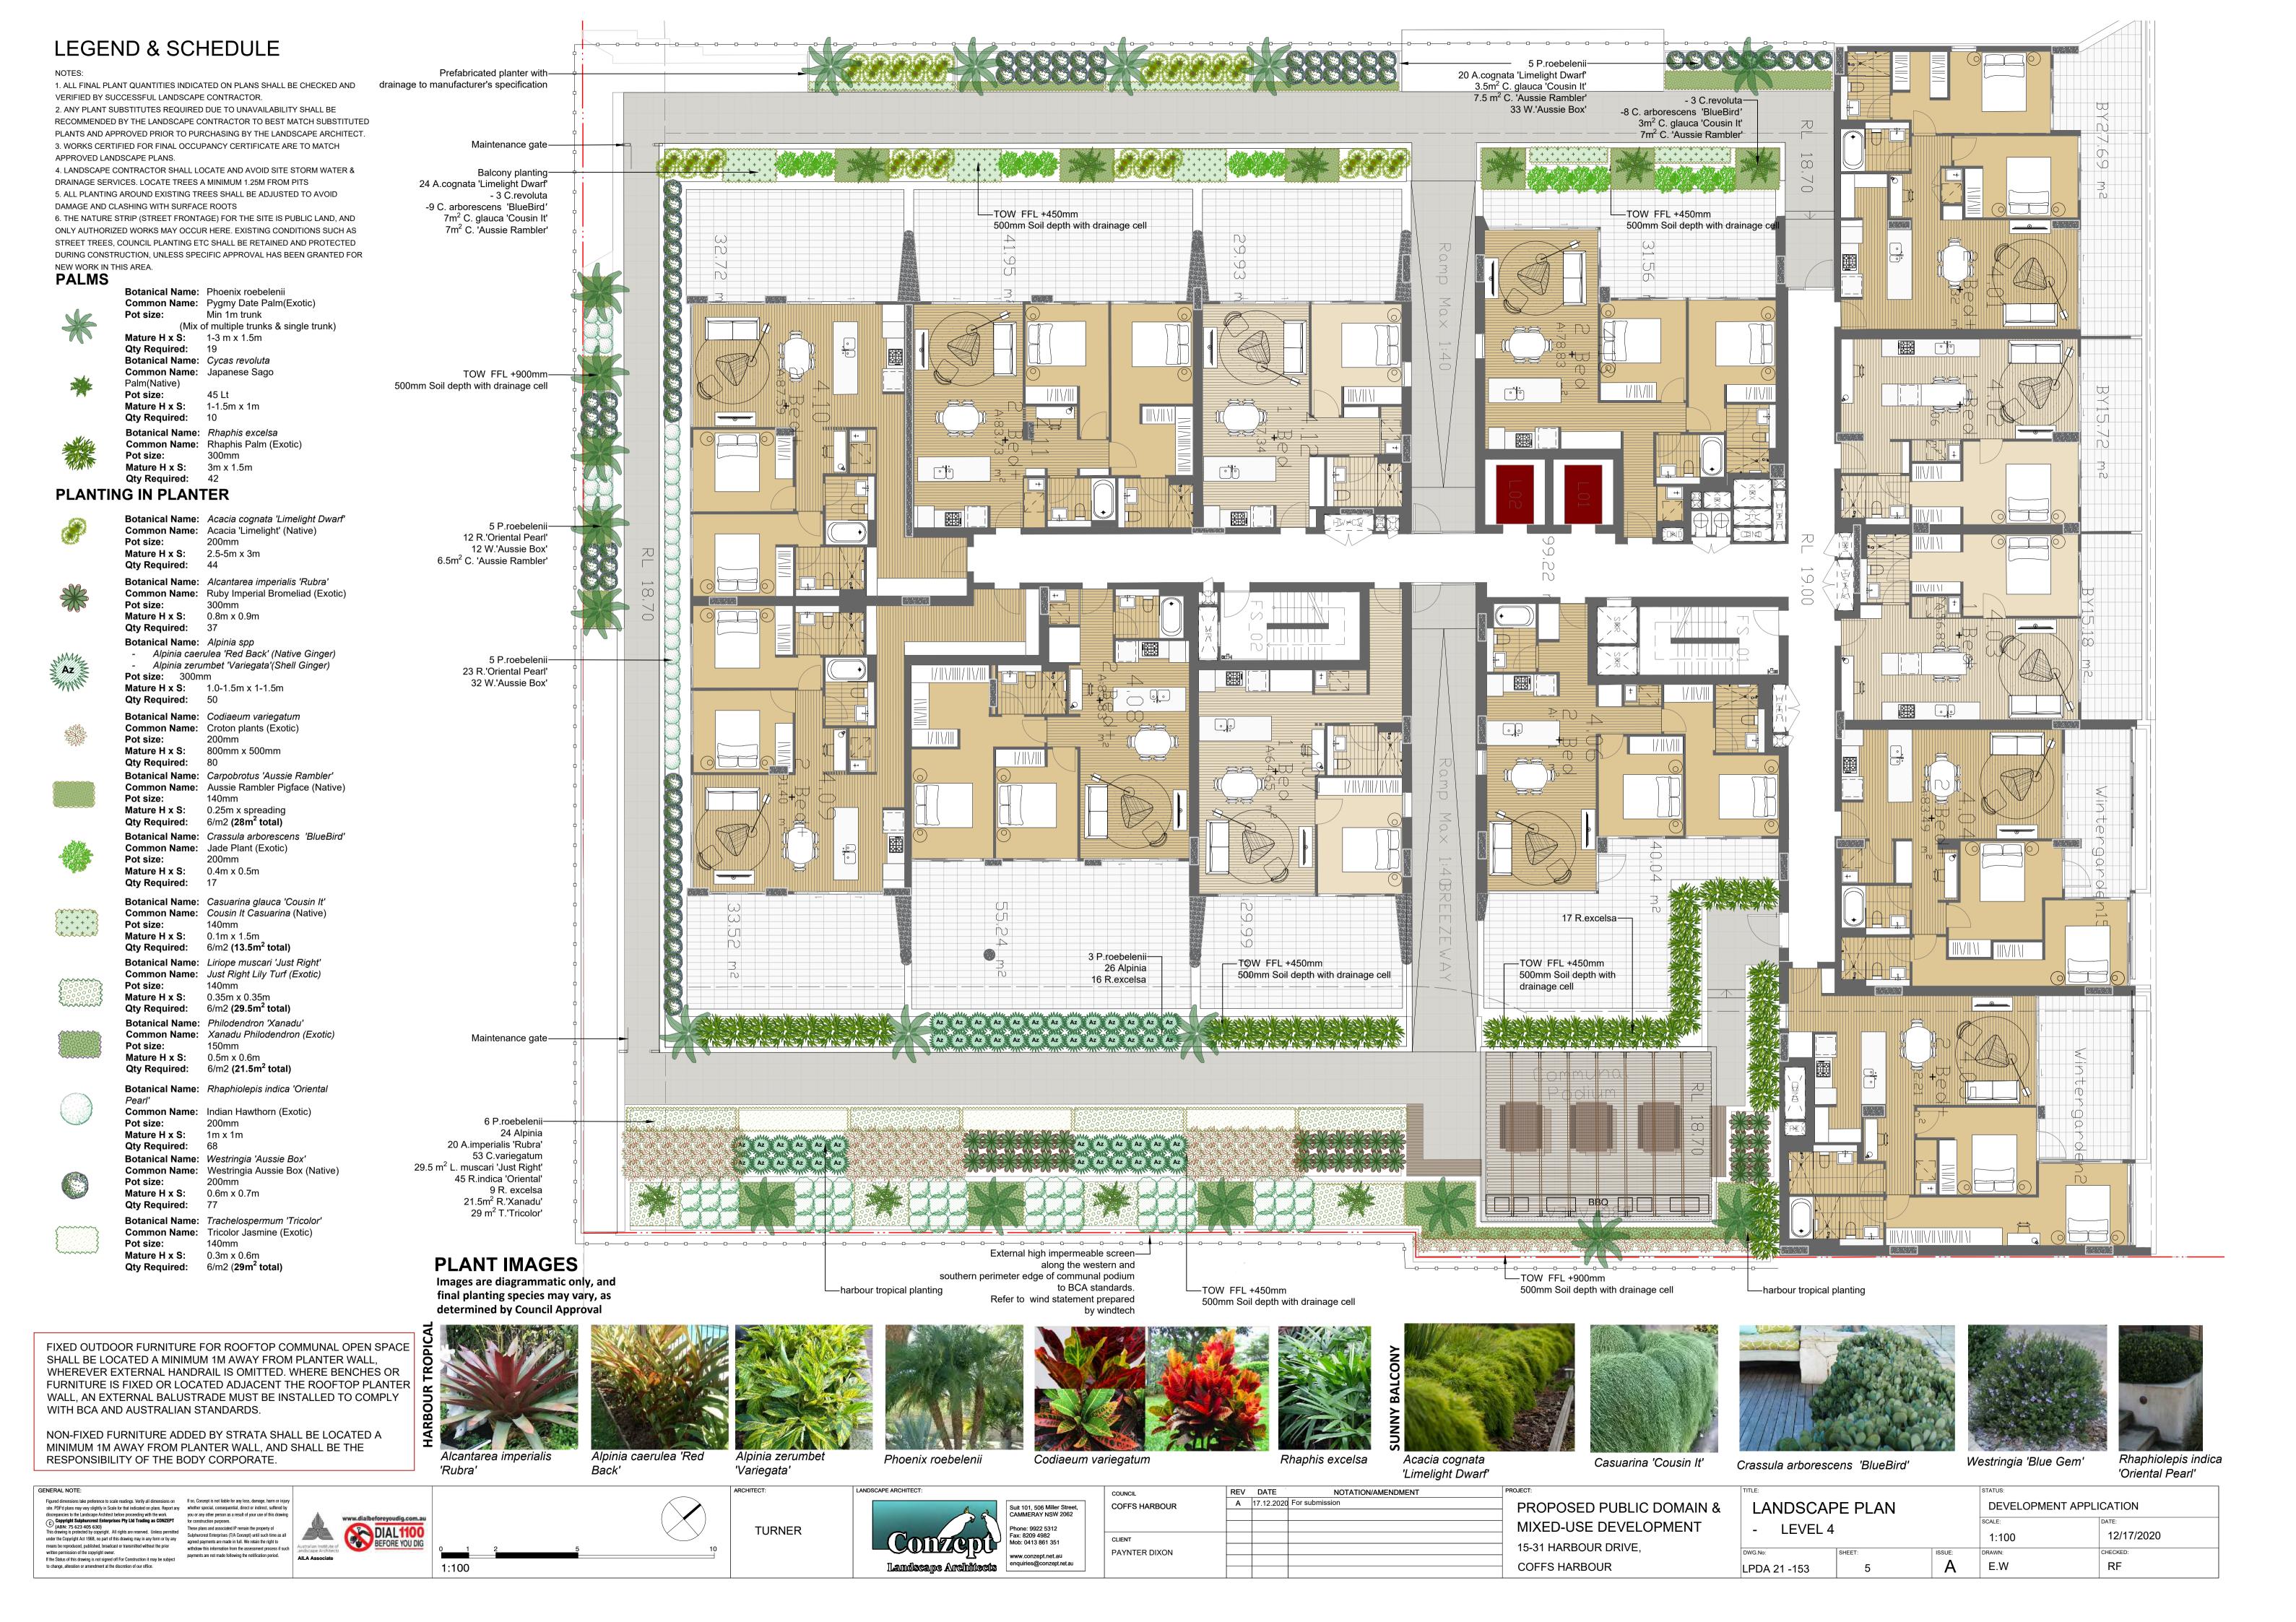



1. CHAIN WIRE MESH PANELS WITH SHADE CLOTH (IF REQUIRED) ATTACHED, HELD IN PLACE WITH CONCRETE FEET

2. ALTERNATIVE PLYWOOD OR WOODEN PALING FENCE PANELS. THE FENCING MATERIAL ALSO PREVENTS **BUILDING MATERIALS OR SOIL** ENTERING THE TPZ

3. MULCH INSTALLATION ACROSS SURFACE OF TPZ (AT THE DISCRETION OF THE PROJECT ARBORIST). NO EXCAVATION, CONSTRUCTION ACTIVITY, GRADE CHANGES, SURFACE TREATMENT OR STORAGE OF MATERIALS OF ANY KIND IS PERMITTED

4. BRACING IS PERMISSIBLE WITHIN THE TPZ. INSTALLATION OF SUPPORTS TO AVOID DAMAGING ROOTS


WITHIN THE TPZ

5. PRUNING & MAINTENANCE TO TREE REFER TO AS 4373-2007 PRUNING OF AMENITY TREES

PROVIDE FENCING AS DETAILED TO ALL TREES PROPOSED TO BE RETAINED ON THE SUBJECT SITE FENCING TO BE LOCATED TO THE DRIP LINE OF TREES OR AS INDICATED ON PLANS OR DIRECTED ON-SITE BY ARBORIST. NO STOCKPILING WITHIN FENCE PERIMETERS.

TREE PROTECTION ZONE

N.T.S

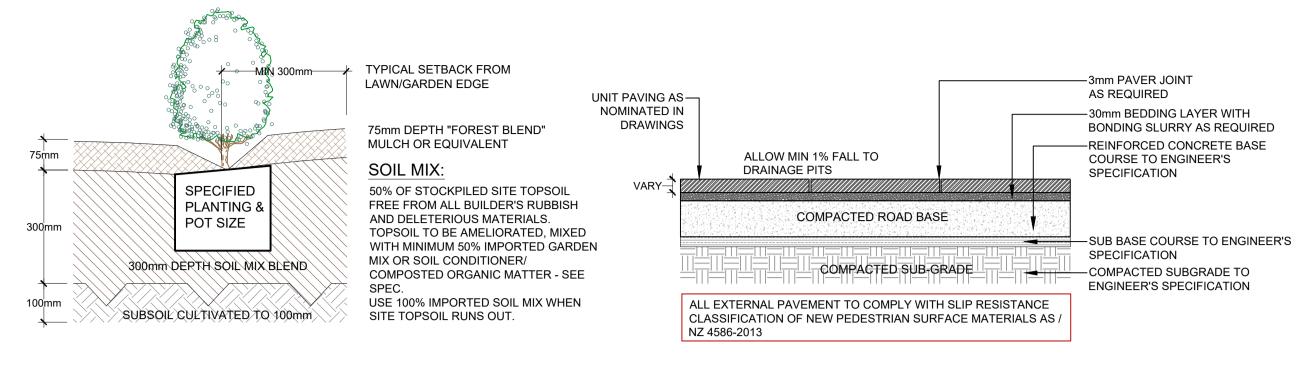


TYPICAL GARDEN PREPARATION DETAIL


SCALE 1:10

(ONLY APPLICABLE FOR PLANTING AREA OUTSIDE TREE PROTECTION ZONE OF TREES TO BE RETAINED. NO CHANGES ARE TO OCCUR TO EXISTING LEVELS, INCLUDING RIPPING/CULTIVATING OF THE SOIL WITHIN THE TPZ OF TREES TO BE RETAINED ON SITE)

TYPICAL PAVING DETAIL

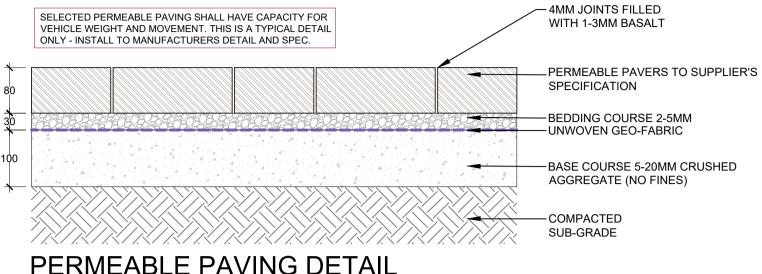


PERMEABLE PAVING DETAIL **SCALE 1:15**

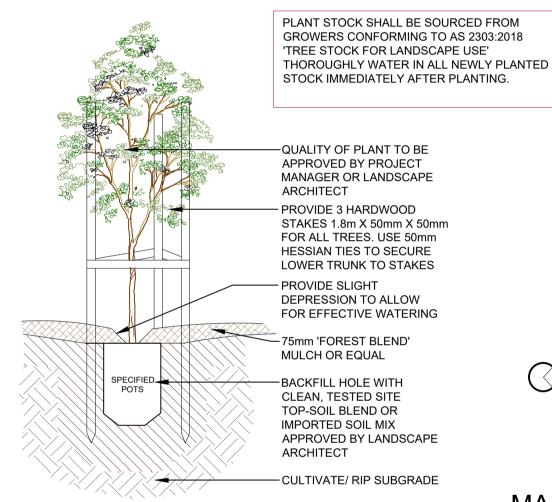

TREE PLANTING DETAIL

SCALE: 1:10

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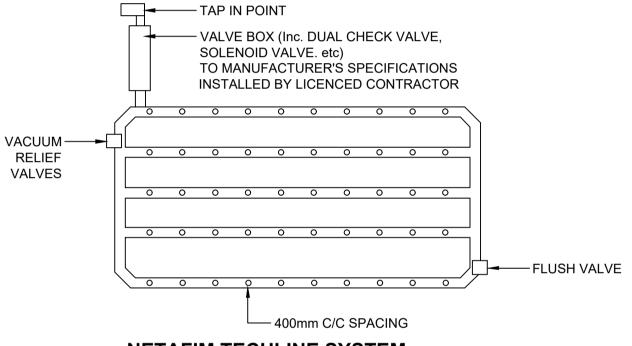


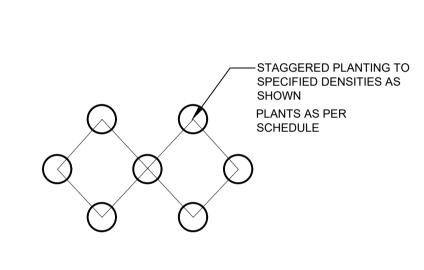MASS PLANTING SETOUT

N.T.S



'FOR ADVANCED TREE PLANTING IN HIGH WIND AND ROOFTOP LOCATIONS, IT IS RECOMMENDED THAT AN APPROVED ROOT BALL ANCHORING SYSTEM EQUAL TO 'PLATIPUS ANCHORS' SHALL BE USED. INSTALL AS PER THE MANUFACTURERS SPECIFICATION'




NETAFIM TECHLINE SYSTEM

TYPICAL IRRIGATION


TO HYDRAULIC ENG'S DETAILS

NOTE: FLOW RATE FROM WATER SOURCE ON SITE IS TO BE ADEQUATE TO ENSURE MINIMUM PERFORMANCE FOR THE INSTALLED DRIP IRRIGATION SYSTEM ACROSS THE SITE

PAVING FINISHES 1: SEASAME GREY 2: ANTIQUE **PAVING SIZE** A: 600 X 400mm B: 600 X 200mm C: CUT TO SUIT

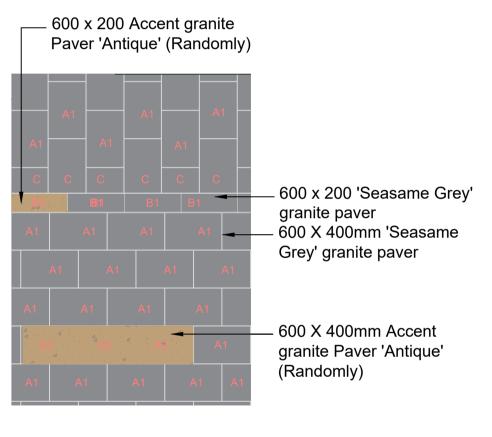

TYPICAL PAVING (PUBLIC DOMAIN)

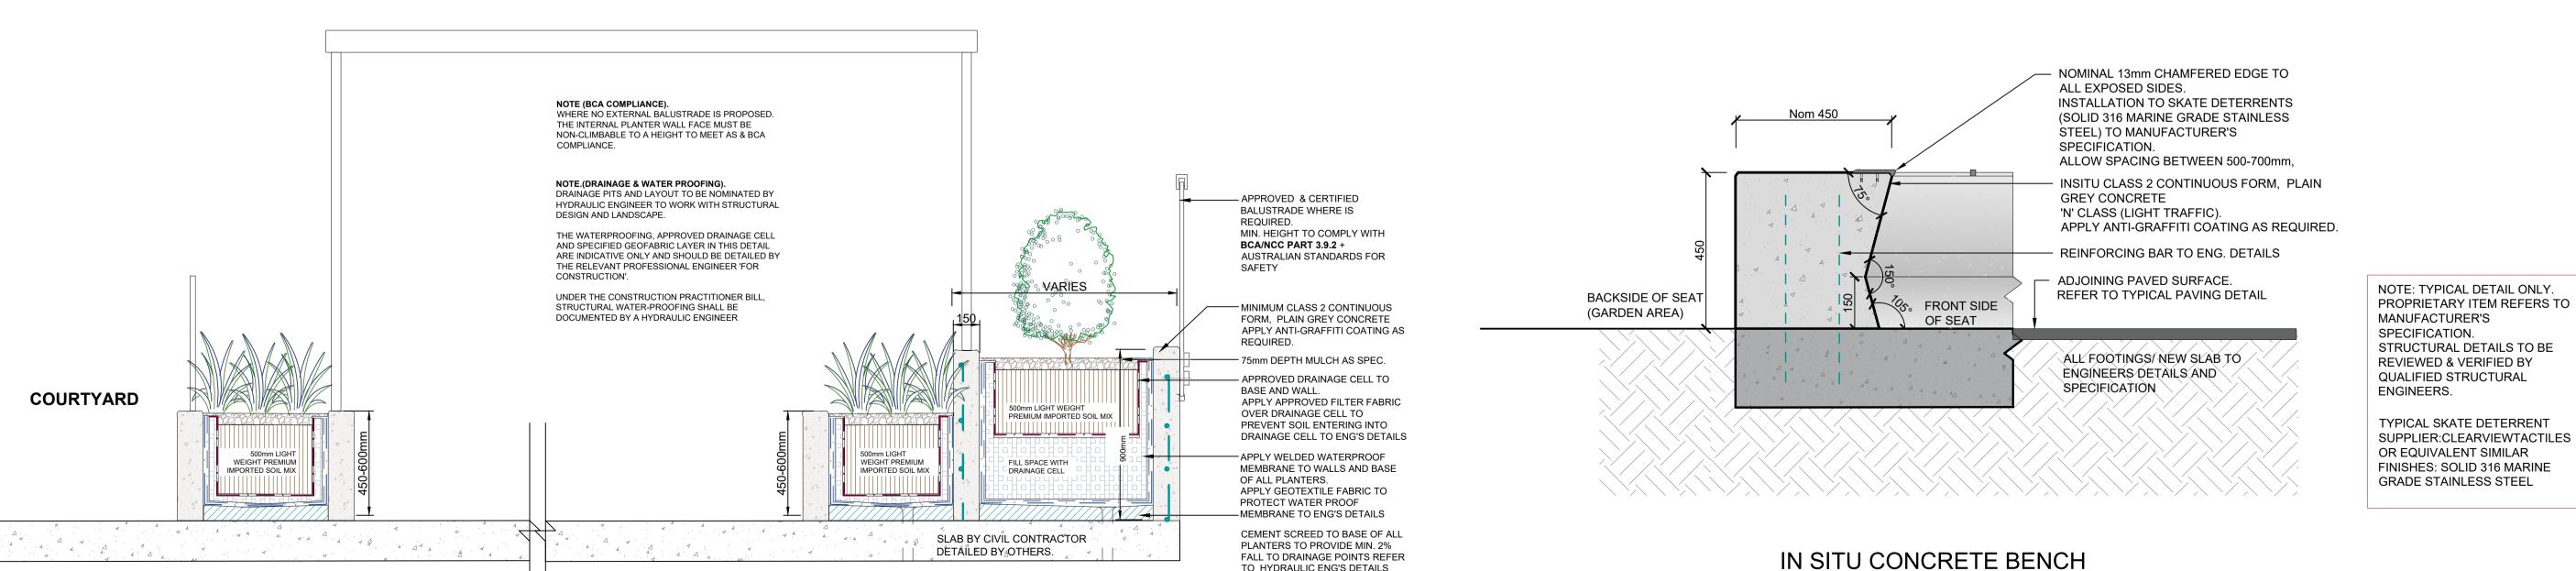

PLANTER ON SLAB DETAIL

SCALE 1:20

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AILA Associate

TURNER

Landscape Architects


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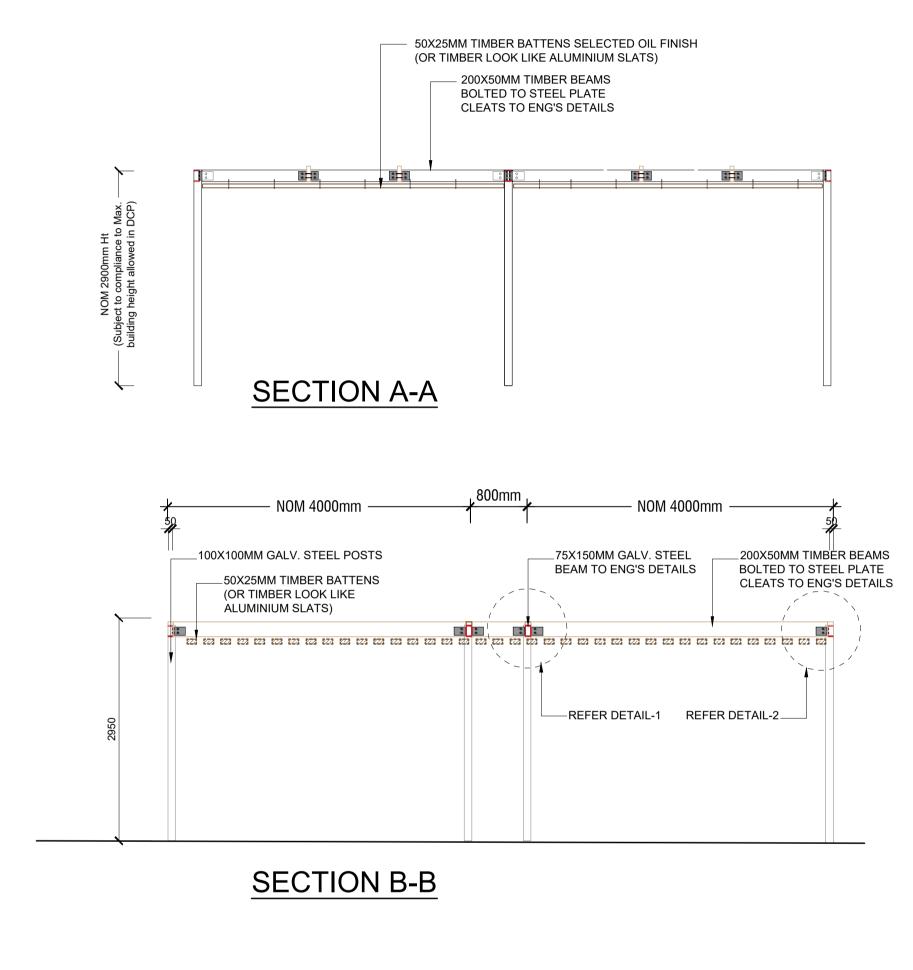
NOTATION/AMENDMENT REV DATE A 17.12.2020 For submission COFFS HARBOUR 15-31 HARBOUR DRIVE, PAYNTER DIXON COFFS HARBOUR

PROPOSED PUBLIC DOMAIN & MIXED-USE DEVELOPMENT

SCALE: 1:10

DETAILS 1 DEVELOPMENT APPLICATION 12/17/2020 AS SHOWN @ A1 Α RF E.W LPDA 21 -153



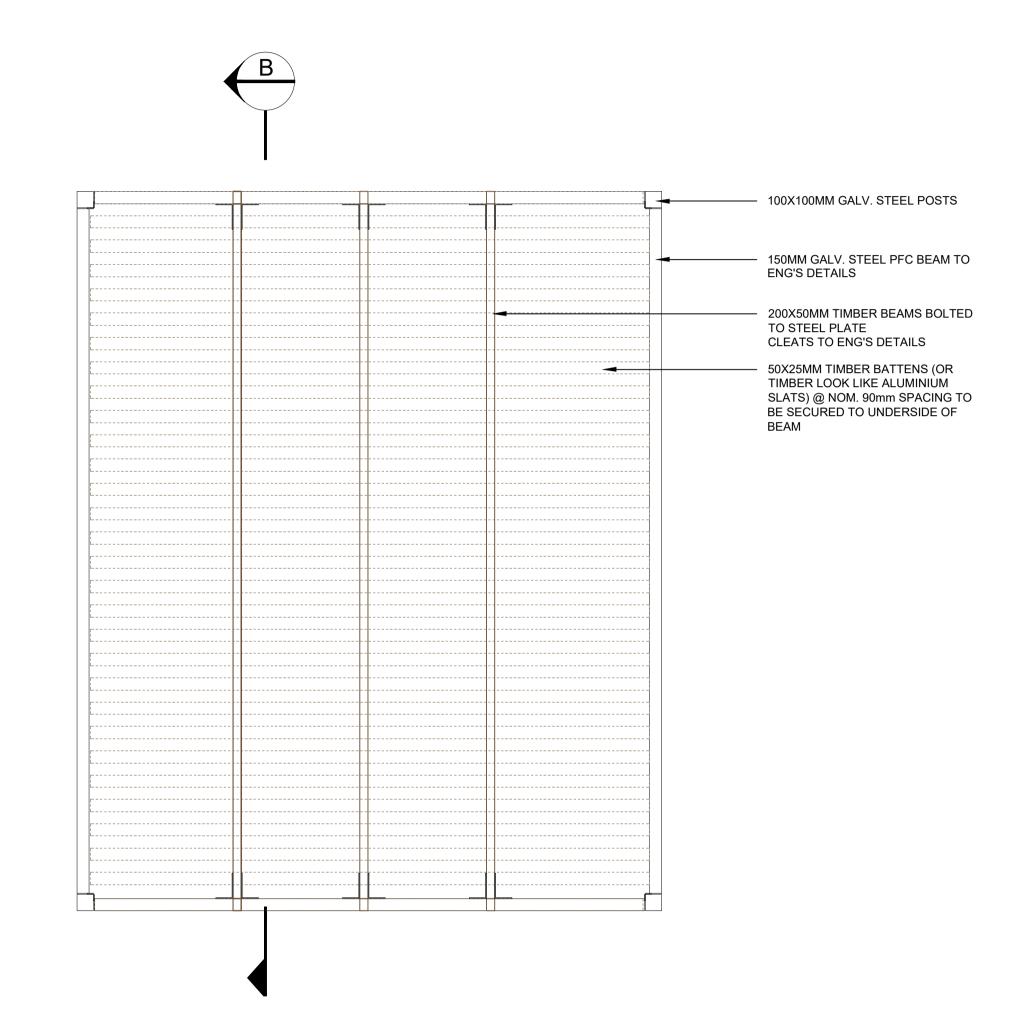


TYPICAL PERGOLA DETAIL SCALE 1:20


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INSERT: **DETAIL-1**



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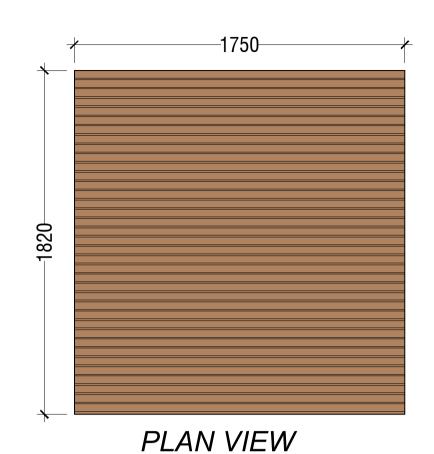


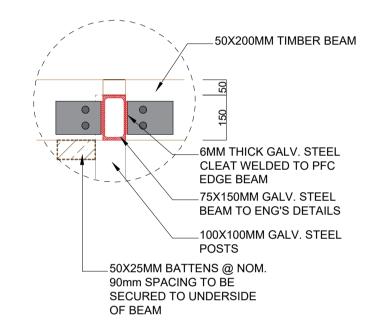

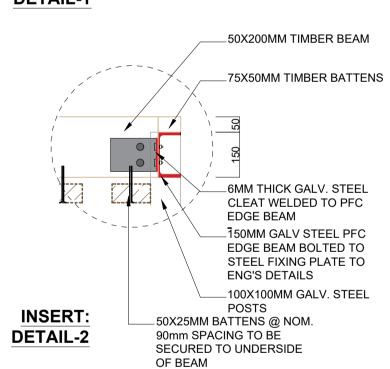


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				MIXED-USE DEVELOPMENT
CLIENT				45.04.14.00.04.00.00.00.00.00
PAYNTER DIXON				15-31 HARBOUR DRIVE,
				COFFS HARBOUR
				COLLAURDOOK

TITLE:			STATUS:	
DETAILS 2	- PERGOLA	DEVELOPMENT APPLICATION		
			SCALE:	DATE:
			AS SHOWN @ A1	12/17/2020
DWG.No:	SHEET:	ISSUE:	DRAWN:	CHECKED:
LPDA 21 -153	7	Α	E.W	RF








OUTDOOR DAYBED

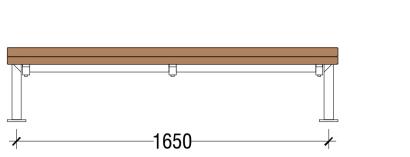

FRONT ELEVATION

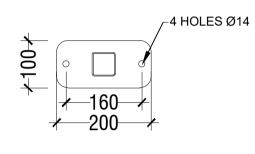

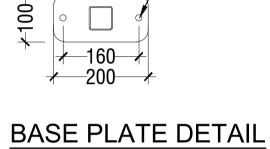

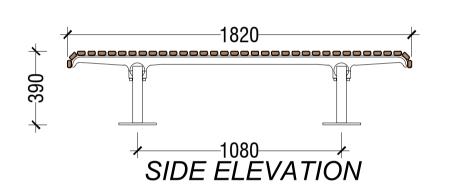

SUPPLIED BY STREET FURNITURE AUSTRALIA PRODUCT CODE: CMP9 FURTHER DETAIL REFER TO MANUFACTURER'S SPECIFICATION

TYPICAL OUTDOOR DAYBED

SCALE 1:20








BIN HOUSING

SCALE: NTS

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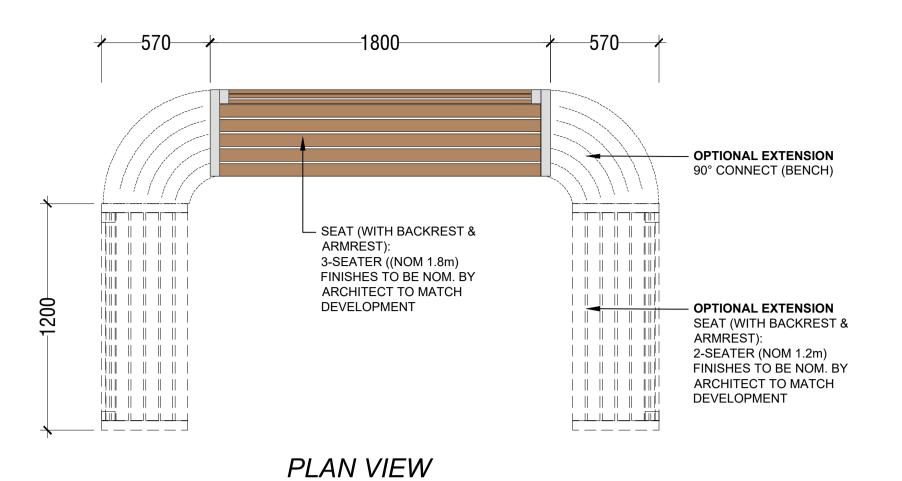


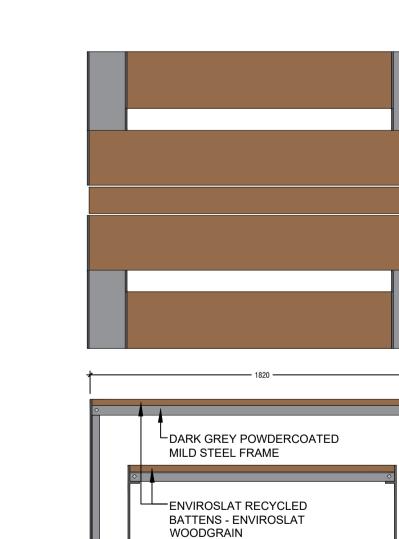


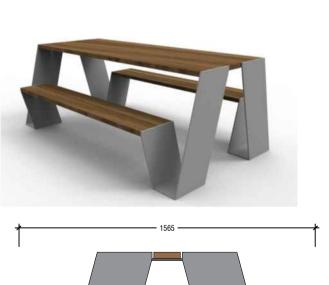BOLT-DOWN FIXING NOTE: DRAWING IS INDICATIVE ONLY. PRODUCT BY COMMERCIAL SYSTEMS AUSTRALIA. REFER

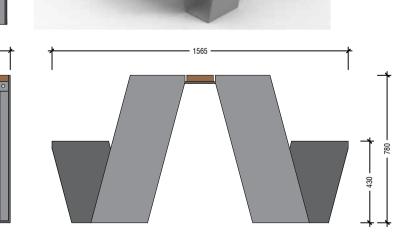TYPICAL OUTDOOR DINNING SETTING SCALE 1:20

MANUFACTURER'S SPECIFICATIONS & INSTRUCTIONS FOR INSTALLATION




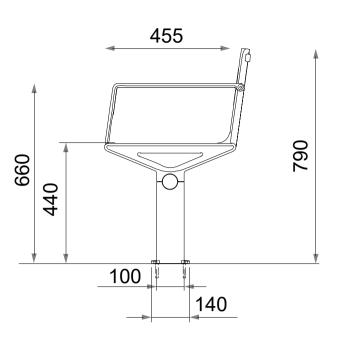


SURFACE FIXED **PEDESTAL** ELEVATION

TYPICAL COMBINATION OF MODULAR SEATS

MANUFACTURER: STREET FURNITURE AUSTRALIA MODEL: ARIA SCALE NTS

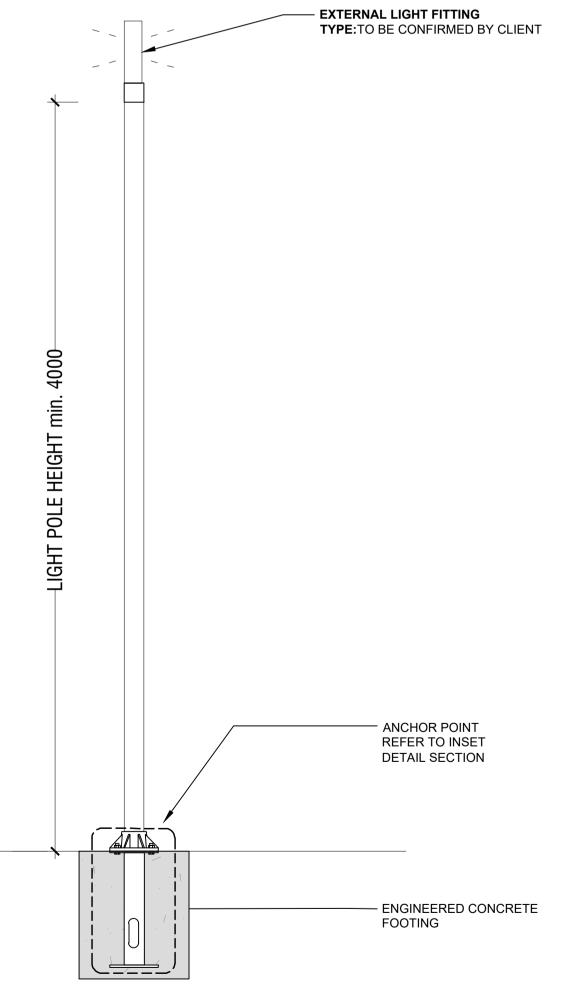

INDICATIVE DETAILS ONLY. NOT FOR CONSTRUCTION. SHOP DRAWING & SPECIFICATION FOR PROPRIETARY ITEMS TO BE PROVIDED BY MANUFACTURER. APPROVED SIMILAR EQUIVALENT PRODUCTS TO BE NOM. BY CLIENT

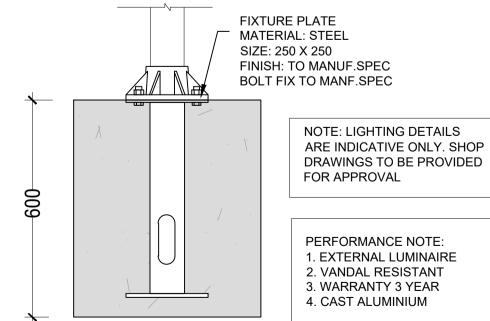

INDICATIVE POLE LIGHT INSTALLATION

SCALE: nts REFER TO MANUFACTURER'S SPECIFICATION

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Suit 101, 506 Miller Street, Fax: 8209 4982

COUNCIL	REV	DATE	
COFFS HARBOUR	Α	17.12.2020	F
CLIENT			
PAYNTER DIXON			

DUNCIL	REV	DATE	NOTATION/AMENDMENT	PROJECT:
OFFS HARBOUR	Α	17.12.2020	For submission	PROPO
				111010
				MIXED.
JENT				
AYNTER DIXON				15-31 HA

ROJECT:	TITLE:
PROPOSED PUBLIC DOMAIN &	DET
MIXED-USE DEVELOPMENT	
15-31 HARBOUR DRIVE,	DWG.No:
COFFS HARBOUR	LPDA 21

TITLE:			STATUS:	
DETAILS 3	- FURNITURI	Ε	DEVELOPMENT APPLICATION	
			SCALE:	DATE:
			AS SHOWN @ A1	12/17/2020
DWG.No:	SHEET:	ISSUE:	DRAWN:	CHECKED:
LPDA 21 -153	8	Α	E.W	RF